# STAPLETON MCA

### PROJECT LOCATION

8371 E. NORHTFIELD BLVD.

#### **JURISDICTION**

CITY OF DENVER

**DESCRIPTION OF WORK** NEW TENANT FINISH FOR THE STAPLETON MASTER COMMUNITY ASSOCIATION

#### PROJECT DIRECTORY

#### <u>ARCHITECT</u>

SEMPLE BROWN DESIGN, P.C. Address: 1160 Santa Fe Drive Denver, CO, 80204 Phone: 303.571.4137 Direct: 720.509.8806 Contact: Mary Kay Sunset Email: mksunset@semplebrown.com

#### **BUILDING MECHANICAL/ MECHANICAL DESIGN-BUILD ENGINEER**

Address: xx Phone: xx Direct: xx Contact: xx

#### **ELECTRICAL ENGINEER**

Address: xx Phone: xx Direct: xx Contact: xx Email: xx

#### DRAWING INDEX

SHEET NO.

A2.02 **ENLARGED BACK-OF-HOUSE** PLANS AND ELEVATIONS

A2.06

A3.01

ARCHITECTURE A0.00 **COVER SHEET** FLOOR PLAN A1.01 A1.02 REFLECTED CEILING PLAN A1.03 ELECTRICAL PLAN A2.01 ENLARGED RESTROOM PLANS AND ELEVATIONS A2.03 ENLARGED OFFICE PLANS AND **ELEVATIONS** A2.04 **ENLARGED BREAK ROOM** 

#### PLANS AND ELEVATIONS INTERIOR ELEVATIONS **INTERIOR ELEVATIONS DETAILS**


#### GENERAL SYMBOL LEGEND

#### **BUILDING ELEVATION:** DRAWING # ਛ<1 |A1.01|1ੇ>ਛ SHEET#

INTERIOR ELEVATION: DRAWING #

SHEET#

STRUCTURAL GRID:

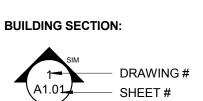

WALL SECTION: — DRAWING #

(A1.01) SHEET# CALL OUT DETAIL:

DRAWING # SHEET# **SPOT ELEVATION / DATUM:** 

## **REVISION TAG:**

**ROOM TAG:** 

/1\— REVISION#

**ROOM NAME** 101 - ROOM#

#### FLOOR TAG: F10 FLOOR TYPE

## **FURNITURE TAG:**

FURN10 - FURNITURE TYPE

## DOOR TAG: 101A DOOR # **CEILING TAG:**

CEILING TYPE **CEILING HEIGHT** WALL TAG:

<1i>→ - WALL TYPE WINDOW TAG:

— WINDOW TYPE **ROOF TAG:** 

### SPECIALTY EQUIPMENT TAG:

SE10 — EQUIPMENT TYPE

ROOF TYPE

PLUMBING FIXTURE TAG: (PF10) — FIXTURE TYPE

**TOILET ACCESSORY TAG:** TA10- ACCESSORY TYPE

## LIGHT FIXTURE TAG:


FIXTURE TYPE - SWITCH#

FLOOR PLAN LEGEND:

[N] CONSTRUCTION

[E] CONSTRUCTION TO

### **VICINITY MAP**

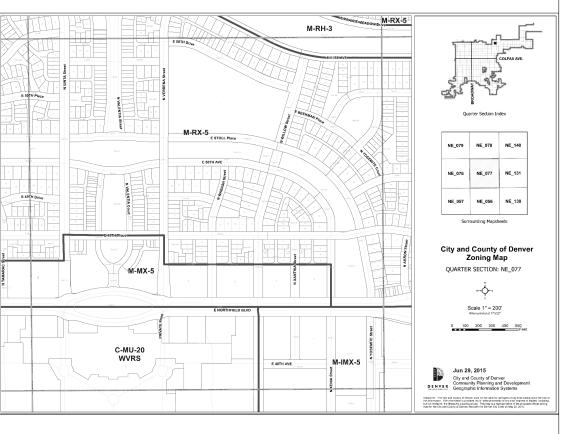

THLD

TOW

#### PROJECT ABBREVIATIONS

EXISTING REMOVE ANGLE AUDIO/VISUAL ANCHOR BOLT ACOUS ACCOUSTICAL ACCOUSTICAL CEILING TILE ACT AREA DRAIN or ACCESS DOOR ADDENDUM ADJACENT or ADJUSTABLE ABOVE FINISHED FLOOR AGG AGGREGATE AHU AIR HANDLING UNIT ALT ALTERNATE ALUM ALUMINUM ANOD ANODIZED APPROX APPROXIMATE ARCH ARCHITECTURAL ARCHITECT'S SUPPLEMENTAL INSTRUCTIONS ASPH ASPHALT

AUTO AUTOMATIC

**AVENUE** 

AVERAGE

BOTTOM OF

BITUMINOUS

BEAM or BENCH MARK

B.O.F. BY OWNER, FUTURE

BOTTOM

BEARING

BASEMENT

CAULKING

CABINET

CENTERLINE

DIRECTIVE

CABLE TELEVISION

CCTV CLOSED CIRCUIT TELEVISION

RANSPORTATION

COUNTERFLASHING

CORNER GUARD

CIRCUMFERENCE

CONTROL JOINT

CAST IN PLACE

CEMENTITIOUS

CONSTRUCTION CHANGE

BOARD

BLKG BLOCKING

BASE

ACOUSTICAL WALL PANEL

AVE

POUND(S) or NUMBER

CHANGE ORDER or CLEANOUT COL COLUMN CONC CONCRETE CONF CONFERENCE CONN CONNECTION CONSTR CONSTRUCTION CONT CONTINUOUS CONTR CONTRACTOR CORR CORRIDOR or CORRUGATED CERAMIC TILE CTR COUNTER CUBIC CUBIC YARD DAMP DAMPROOFING DOUBLE DEGREE DEMO DEMOLISH or DEMOLITION DEPT DEPARTMENT DRINKING FOUNTAIN DIAMETER DIMENSION DISP DISPENSER DIVISION DOWN DOOR DOWNSPOUT DETAIL DRAWING DWR DRAWER EAST EACH EXPANSION BOLT EXHAUST DUCT FXHAUST FAN or EACH FACE EXPANSION JOINT **ELEVATION** ELEV ELEVATOR EMER EMERGENCY ENGR ENGINEER

EOS

EDGE OF SLAB

ESTIMATE

EACH WAY

**EXTERIOR** 

ELECTRIC WATER COOLER

EWH ELECTRIC WATER HEATER

EQUIP EQUIPMENT

ES EACH SIDE

CLG CEILING

CLOS CLOSET

CENTIMETERS

CONCRETE MASONRY UNIT

CLR CLEAR

**FARENHEIT** FIRE ALARM FIRE ALARM CABINET FACP FIRE ALARM CONTROL PANEL FURNISHED BY OTHER(S) FLOOR DRAIN or FIRE DAMPER FOUNDATION FIRE EXTINGUISHER FIRE EXTINGUISHER CABINET FINISHED FLOOR FINISHED FLOOR LINE FIRE HYDRANT FIRE HOSE CABINET FHMS FLAT HEAD MACHINE SCREW FHV FIRE HOSE VALVE FHWS FLAT HEAD WOOD SCREW FIN FINISH(ED) FIXT FIXTURE FLG FLASHING FLR FLOOR(ING) FLUOR FLUORESCENT FOC FACE OF CONCRETE FOF FACE OF FINISH

FOM FACE OF MASONRY FACE OF STUD FIRE RESISTIVE or FIRE RATED FIRE RETARDANT TREATED FOOT (FEET) FOOTING FURN FURNISH(ED) FURR FURRED or FURRING FUT FUTURE FIRE VALVE CABINET GRAB BAR GENERAL CONTRACTOR GLASS or GLAZING

GALV GALVANIZED GCMU GLAZED CONCRETE MASONRY GROUND GR GRADE GROUT GWB GYPSUM WALLBOARD GYP GYPSUM GYP. BD. GYPSUM BOARD HAS HEADED ANCHOR STUD HOLLOW CORE or HANDICAPPED HDAS HEADED DEFORMED ANCHOR HDR HEADER

HDWR HARDWARE

HM HOLLOW METAL

HORIZ HORIZONTAL

HOUR HEIGHT HTR HEATER HVAC HEATING, VENTILATION and AIR CONDITIONING HOT WATER HWH HOT WATER HEATER HWY HIGHWAY INTERNATIONAL BUILDING CODE INSIDE DIAMETER INCH(ES) INCAND INCANDESCENT INCL INCLUD(ED) INFO INFORMATION INSUL INSULATION or INSULATED INT INTERIOR INTMED INTERMEDIATE INV INVERT

JANITOR CLOSET JOIST JOINT KNOCKDOWN KITCHEN KNOCKOUT KICK PLATE LABORATOR\ LAMINATE LAVATORY LDR LEADER LEFT HAND LKR LOCKER LIGHTING PANEL or LIGHT PROOF LINTEL MACH MACHINERY

MIRR MIRROR

MTD MOUNT(ED)

METAL

MISCELLANEOUS

MASONRY OPENING

MILLIMETERS

PNL PANEL MAG MAGNETIC PROJ PROJECT MAS MASONRY MATL MATERIAL MAXIMUM MOISTURE BARRIER MECH MECHANICAL MED MEDIUM MEMB MEMBRANE MEP MECHANICAL, ELECTRICAL and PLUMBING MEZZ MEZZANINE MFR MANUFACTURER MANHOLE MINIMUM

MUL MULLION N NORTH NIC NOT IN CONTRACT NUMBER NOM NOMINAL NRC NOISE REDUCTION COEFFICIENT NTS NOT TO SCALE OVERALL ON CENTER OUTSIDE DIAMETER OUTSIDE FACE OFF OFFICE OPPOSITE HAND OPNG OPENING OPPOSITE OUTSIDE-TO-OUTSIDE PAINT(ED) PROPERTY LINE PREVIOUSLY AWARDED PAR PARALLEL PBO PROVIDED BY OTHERS PC PRECAST PERF PERFORATED PERIM PERIMETER PKG PARKING PL PLATE PLAM PLASTIC LAMINATE PLAS PLASTER

PLBG PLUMBING PLY PLYWOOD POL POLISHED PR PAIR or PROPOSAL REQUEST PREFAB PREFABRICATED PRESTR PRESTRESSED PRIM PRIMARY PSF POUNDS PER SQUARE FOOT POUNDS PER SQUARE INCH POST TENSIONED or PORCELAIN PTD PAINTED PTDR PAPER TOWEL DISPENSER AND STOR STORAGE RECEPTACLE STRUCT STRUCTURE or STRUCTURAL PTN PARTITION SUSP SUSPEND(ED) PTR PAPER TOWEL RECEPTACLE SYM SYMMETRICAL PVC POLYVINYL CHLORIDE PVMT PAVEMENT QT QUARRY TILE QTY QUANTITY RISER RAD RADIUS

RB RUBBER BASE

RBC RUBBER BASE COVE

RBS RUBBER BASE STRAIGHT

RUBBER TILE ROOF DRAIN or ROAD REFER TO or REFERENCE RECESS(ED) RECPT RECEPTACLE REFRIGERATOR or REFRIGERATED REINF REINFORCED REQD REQUIRED RESIL RESILIENT REVISE, REVISED or REVISION(S) RESILIENT FLOORING ROOFING REFLECTED RIGHT HAND RAIN LEADER ROUGH OPENING ROD ROOF OVERFLOW DRAIN ROW RIGHT OF WAY REVOLUTIONS PER MINUTE REVERSE (SIDE) RAIN WATER CONDUCTOR SOUTH or SEALED SOLID CORE SCHED SCHEDULE SOAP DISPENSER SQUARE FEET SHEET SHTG SHEATHING SHWR SHOWER SIMILAR SOFF SOFFIT SPECS SPECIFICATION(S) SPKL SPRINKLER SPKR SPEAKER SPRT SUPPORT SQUARE SINK RECEPTACLE STAINLESS STEEL SERVICE SINK

STATION

STEEL

TELE TELEPHONE

TG TEMPERED GLASS

THERM THERMOSTAT

STANDARD

TOP AND BOTTOM

TONGUE AND GROOVE

TOP OF BACK OF CURB

TEMP TEMPORARY or TEMPERATURE

TELEVISION **TYPICAL** UNDERWRITER'S LABORATORY UNFIN UNFINISHED UON UNLESS OTHERWISE NOTED USGS U.S. GEOLOGICAL SURVEY VOLT VARY or VARIES VAPOR BARRIER VINYL COMPOSITION TILE VENT VENTILATION VERT VERTICAL VEST VESTIBULE VERIFY IN FIELD VINYL or SHEET VINYL VENT THROUGH ROOF VINYL WALL COVERING WEST or WIDE WHERE OCCURS WATER CLOSET WITHOUT WATER RESISTANT WALL COVERING WOOD WINDOW WIDE FLANGE or WOOD FLOORING WIRE GLASS WATERPROOF(ING) WORKING POINT WSCT WAINSCOT WWF WELDED WIRE FABRIC YARD

THICK or THICKNESS

TOP OF CONCRETE

TOILET PAPER DISPENSER

TOP OF STEEL

TOP OF WALL

TPTN TOILET PARTITION

TUBE STEEL

THRESHOLD

TOP OF

#### **APPLICABLE CODES:**

- 2009 INTERNATIONAL BUILDING CODE (IBC) 2009 INTERNATIONAL ENERGY CONSERVATION CODE (IECC)
- 2009 INTERNATIONAL FIRE CODE (IFC) 2009 INTERNATIONAL MECHANICAL CODE (IMC)
- 2009 INTERNATIONAL PLUMBING CODE (IPC)
- 2009 INTERNATIONAL FUEL GAS CODE (IFGC) 2014 NATIONAL ELECTRICAL CODE (NEC) 2011 DENVER AMENDMENTS

#### **CODE ANALYSIS:**


- BUILDING CLASSIFICATION: 303.4 ASSEMBLY GROUP A-3.
- **AUTOMATIC FIRE SPRINKLERS: YES**
- MIXED OCCUPANCY: NO
- AREA OF FLOOR: 5997 S.F
- OCCUPANT LOAD: 534
- <u>DISTANCE BETWEEN EXITS:</u> SEE CODE PLAN 1/A0.0: B = 84 FT, MAX BUILDING DIAGONAL (A) = 110 FT, B REQUIRED TO BE NOT LESS THAN
- DEAD END CORRIDOR: SEE CODE PLAN 1/A0.0: NONE
- MAX. EXIT ACCESS TRAVEL DISTANCE: SEE CODE PLAN 1/A0.0: C = 65 FT
- PLUMBING COUNT: PER TABLE 2902.1

**TOTAL OCCUPANCY - 536** MEN/WOMEN - 268

WC REQUIRED: FEMALE 268 / 65 = 5; MALE 268 /125 = 3 WC PROVIDED - 6 WC IN WOMEN, 4 WC & 2 URINAL IN MEN, 1 WC IN

LAVATORIES REQUIRED = 268 / 200 = 2 EACH LAVATORIES PROVIDED - 4 IN WOMEN, 4 IN MEN, 1 IN UNISEX

DRINKING FOUNTAIN REQUIRED/ PROVIDED - 2 MOPSINK REQUIRED/ PROVIDED - 1

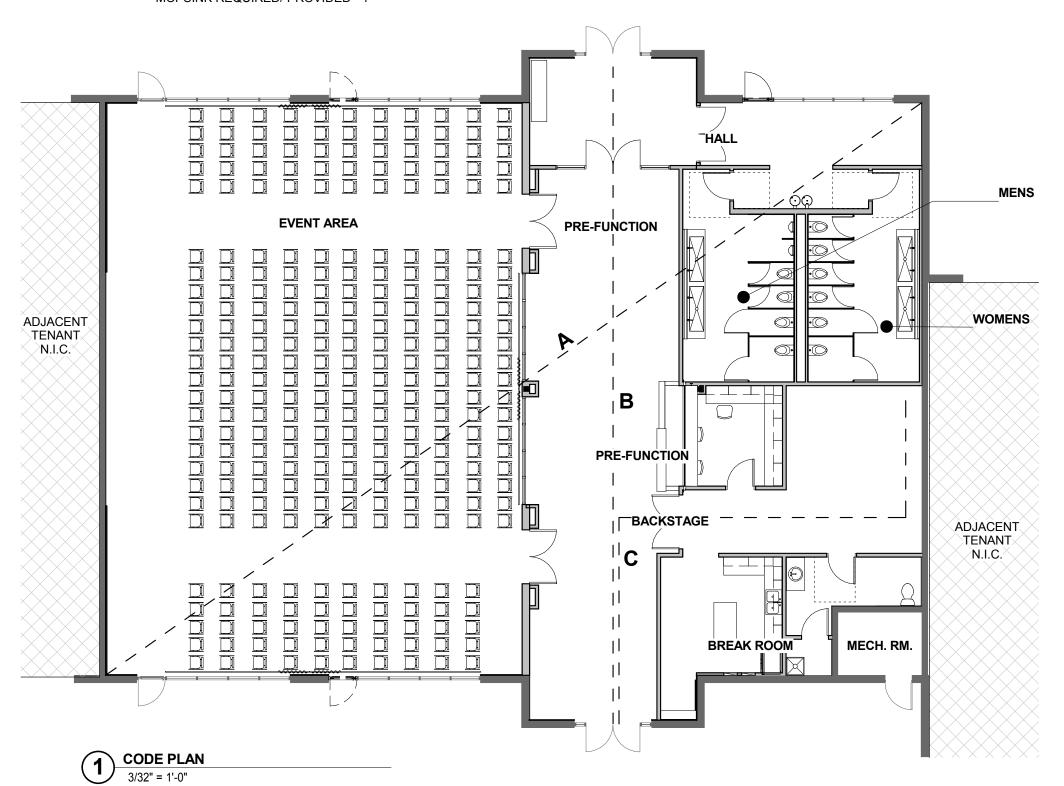



**ARCHITECTS AND DESIGNERS** 

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FINIS

**TENANT** M M STAPLETON

REVISION OWNER REVIEW 01/21/2016 A PROGRESS

NUMBER:

10/05/2015 PROJECT DATE: SHEET TITLE:

**COVER SHEET** 

#### DOOR SCHEDULE NUMBER TYPE HARDWARE COMMENTS Thickness Door Material Door Finish Frame Material Finish TRANSOM WINDOW TO MATCH EXISTING AL & GLASS PANIC 103 SC WOOD PUSH-PULL 0' - 1 3/4" SC WOOD PUSH-PULL 104 7' - 0" 3' - 0" 0' - 1 3/4" KEY CODE ENTRY 105A 7' - 0" 2' - 9 3/4" LOCKSET 105B AL & GLASS LOCKSET TRANSOM WINDOW TO MATCH EXISTING 106 SC WOOD LOCKSET KEY CODE ENTRY OVERHEAD ROLLING SECURITY GRILLE. RE: 106B 10' - 9" 0' - 0 1/2" 12' - 5 1/2" STRUCT. FOR JAMB MOUNT AUTOMATIC FLUSH BOLT ON INACTIVE LEAF 108 SC WOOD LATCHSET 110A PUSH-PULL 8' - 10" SC WOOD 110B 8' - 10" SC WOOD PUSH-PULL 111 SC WOOD LOCKSET 7' - 0" 3' - 0" 0' - 1 3/4"

LATCHSET

	Plumbing Fixture Schedule										
Type Mark	Count	Family and Type	Description	Manufacturer	Model	Comments					
1F	8	Faucet - Single Hole: Faucet - Single Hole	SLOAN LINO EF-200 LAV GAURD 2 E-Z	MFR	MODEL	2 FAUCETS PER SINK					
1S	4	Sink: Sink & Faucet		MFR	MODEL	TROUGH SINK 60" WIDE					
2	10	Tolilet - Elongated: American Standard - Afwall Elongated Flushometer Toilet - 3351.160	Elongated 1.6 GPF Flushometer Toilet	MFR	MODEL						
3	2	Urinal-Wall-3D: Urinal-Wall-3D		MFR	MODEL						
4	1	HighLow_ADA_Bowl_Drinking_FountainBottle_Filler_w_Purifier_in_W all_Box_Below_13012: HighLow_ADA_Bowl_Drinking_FountainBottle_Filler_w_Purifier_in_W all_Box_Below_13012		MFR	MODEL	W/ BOTTLE FILLER					
5	1	Sink Vanity-Round: 19" x 19"				W/ FAUCET					
6	1	Toilet - Floor Mounted: Type									
7	1	Sink Kitchen-Double: 33" x 21"				W/ FAUCET & DISPOSAL					
8	1	Sink - Mop: 24x24									

ſ	
	E 3'-0" X 8'-10" PAIR

S.C. WOOD VENEER WITH


PTD. METAL FRAME RE:

FINISH SCHEDULE

A 6'-0" X 7'-0"

GLASS STOREFRONT

TO MATCH EXISTING

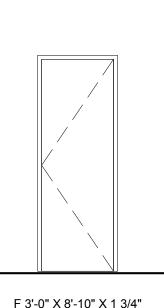

S.C. WOOD VENEER WITH

PTD. MTL. FRAME RE:

FINISH SCHEDULE


B 3'-0" X 7'-0"

RELOCATED SINGLE GLASS

DOOR IN STOREFRONT

C 3'-0" X 7'-0" X 1 3/4"

RE: FINISH SCHEDULE

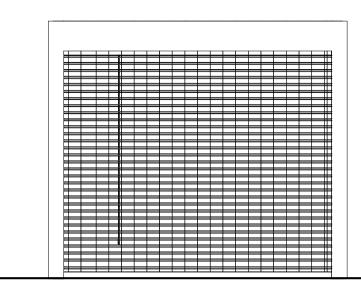

H OVERHEAD COILING SECURITY GRILL

D 3'-0" X 7'-0" X 1 3/4"

RE: FINISH SCHEDULE

PTD. MTL. FRAME


PTD. MTL. DOOR AND FRAME S.C. WOOD VENEER WITH

Specialty Equipment Schedule						
SE	DESCRIPTION					
1	42" GRAB BAR @ 36" AFF					
2						
4						
5	SANITARY DISPOSAL (WOMENS WC STALLS TYP)					
6						
7						
9	MIRROR WITH POLISHED EDGES 4' WIDE X 4' HIGH					
10	MIRROR WITH POLISHED EDGES 4' WIDE X 4' HIGH					
12						
13	MIRROR WITH POLISHED EDGES 4' WIDE X 4' HIGH					
14						

0' - 2"

METAL

112

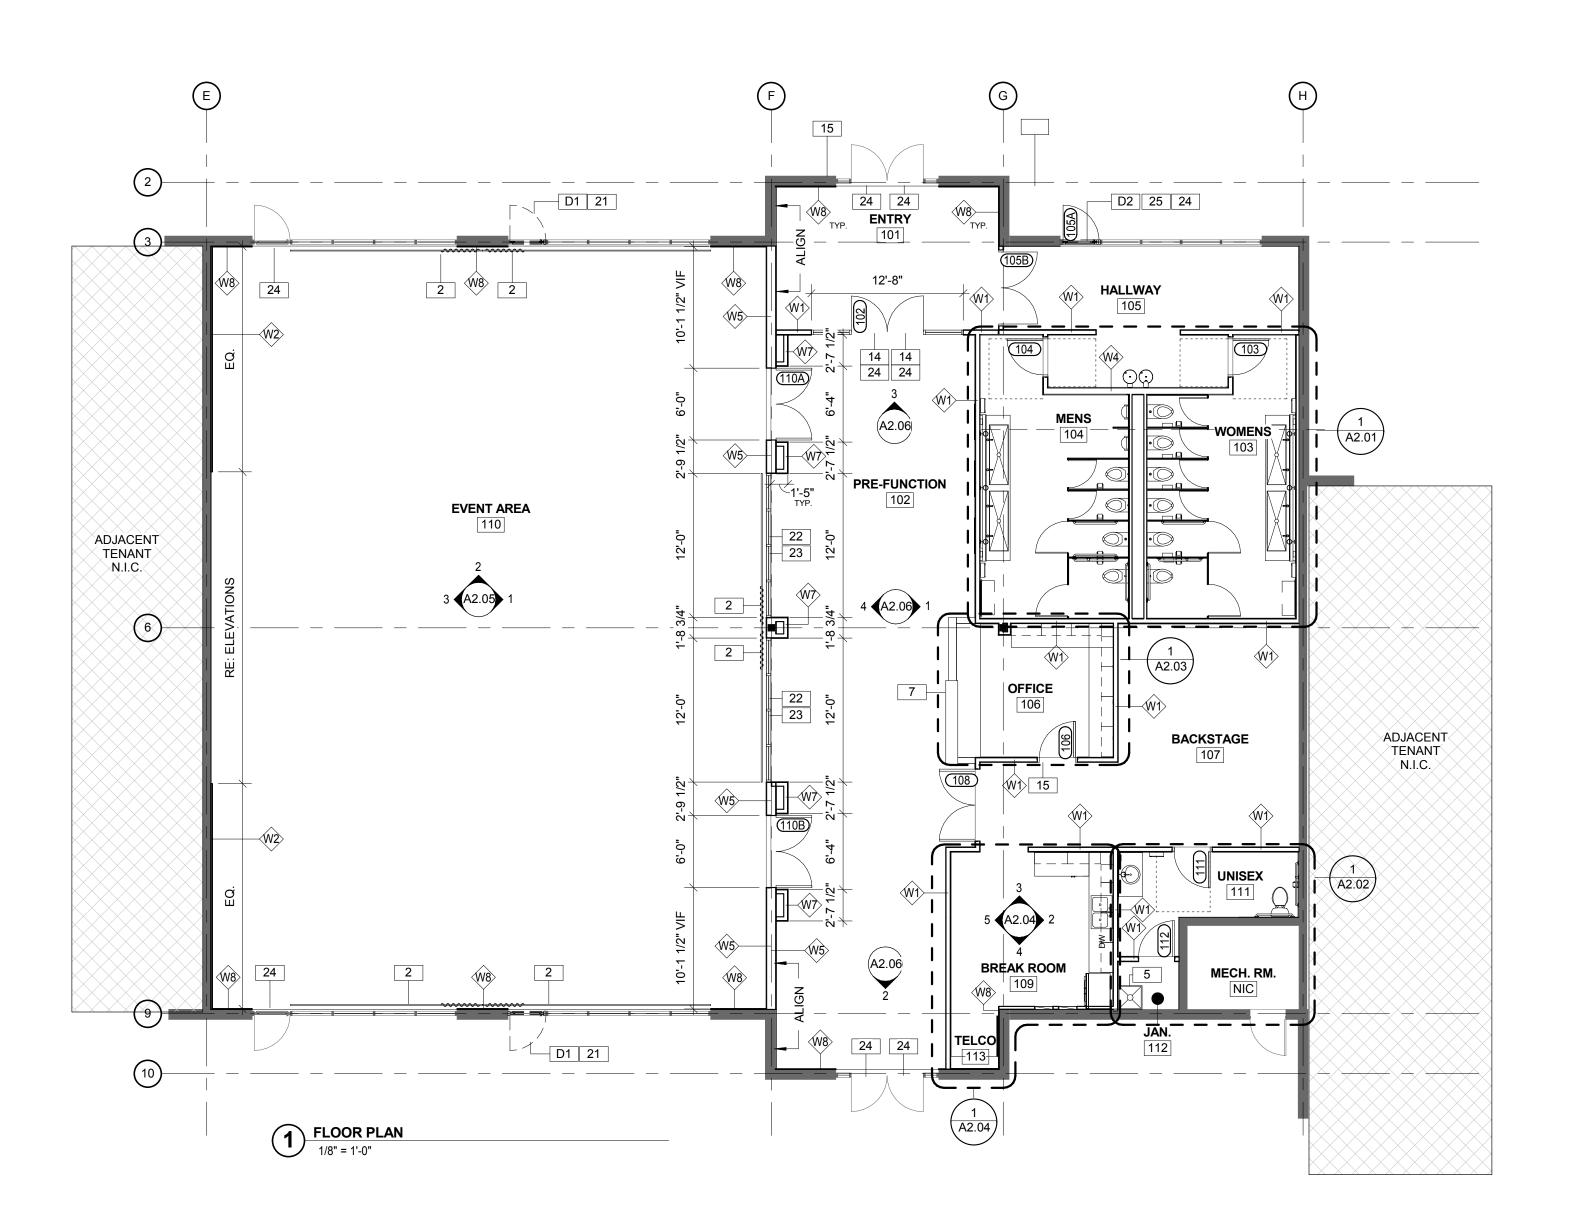

#### WALL-MOUNTED DRAPERY SYSTEM. MOP SINK RE: PLUMBING **SEMPLE** WOOD VENEER RECEPTION DESK WITH QUARTZ SURFACE TRANSATION TOP, RE: ENLARGED PLANS ELEVATIONS AND DETAILS. **BROWN** REUSE SALVAGED STOREFRONT DOORS AT THIS LOCATION. PUSH BUTTON KEY CODE ENTRY DOOR HARDWARE, RE: DOOR SCHEDULE. STOREFRONT GLAZING AND MULLIONS TO MATCH EXISTING. INTERIOR STOREFRONT GLAZING TO MATCH EXTERIOR PRICING DEDUCT ALTERNATE: 1/2" TEMPERED BUTT-GLAZING IN TOP AND BOTTOM CHANNELS. PANIC HARDWARE REQUIRED AT EGRESS DOOR. **ARCHITECTS AND DESIGNERS** INSTALL RELOCATED STOREFRONT DOOR AT INDICATEDLOCATION.

REMOVE STOREFRONT DOOR AND SALVAGE FOR REUSE RE: DOOR

SCHEDULE. PREPARE FOR NEW PANELS AND MULLIONS TO MATCH

REMOVE GLAZING AND SALVAGE FOR REUSE. PREPARE FOR NEW

SALVAGED DOOR.

WALL TYPES

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W4 3 5/8" METAL STUD WITH 5/8" GYP. BD. BOTH SIDES, ACOUSTIC SOUND BATT 10" METAL STUD WITH 5/8" GYP BD. BOTH SIDES TO B.O. DECK COL LINE F

FINIS

TENANT

M

REVISION

A PROGRESS

OWNER REVIEW | 12/18/2015

OWNER REVIEW 01/21/2016

ENGINEERING 01/29/2016

3 5/8" METAL STUD WALL WITH 5/8" GYP. BD. ONE SIDE 3 5/8" METAL STUD WITH 5/8" GYP. BD. ONE SIDE, TO T.O. TOWER 5/8" GYP. BD. OVER EXISTING FRAMING, FULL HEIGHT

3 5/8" METAL STUD WITH 5/8" GYP. BD. BOTH SIDES, ACOUSTIC SOUND BAT

#### **CONSTRUCTION GENERAL NOTES:**

W9 2 1/2" METAL STUD KNEE WALL WITH 5/8" GYP. BD. ONE SIDE

HAT CHANNEL WITH 5/8" GYP. BD. ONE SIDE

NOTES

THE GENERAL CONTRACTOR IS SUPPLIED, HEREIN, WITH THE CONSTRUCTION DOCUMENTS FOR THEIR USE IN PRICING AND CONSTRUCTING THIS WORK. IT IS THE SOLE RESPONSIBILITY OF THE GENERAL CONTRACTOR TO VERIFY ALL EXISTING CONDITIONS AND DIMENSIONS, AND NOTIFY THE ARCHITECT OF ANY DISCREPANCIES OR UNFORSEEN CONDITIONS. CONTRACTOR IS TO COORDINATE PRICING AND CONSTRUCTION INFORMATION ACCORDINGLY.

2. ALL PARTITIONS ARE DIMENSIONED FINISH TO FINISH, UNLESS OTHERWISE NOTED.

3. PARTITIONS SHOWN ALIGNED WITH BASE BUILDING STRUCTURE, SHALL BE FLUSH AND SMOOTH WITH BASE BUILDING STRUCTURE, UNLESS OTHERWISE NOTED. ALL EXISTING CORNER BEADS SHALL BE REMOVED, TAPED AND SPACKLED PROPERLY.

4. CONTRACTOR SHALL PROVIDE THE ARCHITECT WITH SHOP DRAWINGS FOR ALL ITEMS THAT REQUIRE FABRICATION, OR MUST

5. CONTRACTOR SHALL PROVIDE SUBMITTALS OF SPECIFICATIONS FOR APPROVAL BY THE ARCHITECT.

6. THE CONTRACTOR SHALL PROVIDE AND INSTALL APPROVED FIRE EXTINGUISHERS AS REQUIRED. BY THE LOCAL FIRE PROTECTION DISTRICT.

COORDINATE LOCATIONS WITH ARCHITECT PRIOR TO INSTALLATION.

CONTRACTOR IS RESPONSIBLE FOR COORDINATING THE LOCATION OF ALL WALL FRAMING MEMBERS TO FACILITATE THE INSTALLATION OF ALL WALL MOUNTED ELEC. AND MECH. DEVICES, ETC., PER THE ARCHITECT'S DRAWINGS. RE: INTERIOR ELEVATIONS FOR EXACT LOCATIONS OF DEVICES. IF NOT INDICATED, COORDINATE LOCATIONS WITH ARCHITECT PRIOR TO INSTALLATION.

8. CONTRACTOR SHALL PROVIDE AND INSTALL ALL STIFFENERS, BRACINGS, BACK-UP PLATES AND SUPPORTING BRACKETS REQUIRED FOR THE INSTALLATION OF ALL CASEWORK, TOILET ACCESSORIES AND OF ALL FLOOR-MOUNTED OR SUSPENDED MECH. AND ELEC. EQUIPMENT.

9. FIELD VERIFY LOCATION OF ALL MECH. THERMOSTATS WITH ARCHITECT PRIOR TO INSTALLATION. HVAC DOCUMENTS INDICATE GENERAL LOCATION ONLY.

10. LOCATE ALL PLUMBING IN PROTECTED AREAS TO AVOID FREEZING OF PIPES AND TRAPS.

11. LATCHING AND LOCKING DOORS THAT ARE HAND-ACTIVIATED AND WHICH ARE IN A PATH OF TRAVEL SHALL BE OPERABLE WITH A SINGLE EFFORT BY LEVER TYPE HARDWARE, PANIC BARS, PUSH-PULL ACTIVATING BARS, OR OTHER HARDWARE DESIGNED TO PROVIDE PASSAGE WITHOUT REQUIRING THE ABILITY TO GRASP THE OPENING HARDWARE. LOCKED EXIT DOORS SHALL OPERATE AS ABOVE IN THE EGRESS DIRECTION.

12. ALL RIGID CONDUIT, DUCTS, PLUMBING PIPES, AND APPLIANCE VENTS LOCATED IN SOUND ASSEMBLIES SHALL BE ISOLATED FROM THE BLDG. CONSTRUCTION BY MEANS OF RESILIENT SLEEVES, MOUNTS, OR 1/4" MINIMUM THICKNESS APPROVED RESILIENT MATERIALS.

13. APPROVED PERMANENT AND RESILIENT ACOUSTICAL SEALANT SHALL BE PROVIDED ALONG THE JOINT BETWEEN THE FLOOR AND ALL SEPARATION WALLS.

14. PROVIDE SOUND ATTENUATION BATTS WHERE INDICATED ON PLAN

15. GLASS DOORS, ADJACENT PANELS, AND ALL GLAZED OPENINGS WITHIN 18 INCHES OF ADJACENT FLOOR, OR WITHIN 40 INCHES OF ANY LOCKING MECHANISM, SHALL BE OF GLASS APPROVED FOR IMPACT

16. SPECIAL CASEWORK DESIGN TO MEET A.W.I. SPECIFICATIONS SHALL BE PROVIDED ACCORDING TO REFERENCE NOTES AND DETAILS ON THE DRAWINGS. WHERE CONFLICTS BETWEEN A.W.I AND ARCHITECTS DRAWINGS OCCUR, CONTRACTOR TO PROVIDE THE ASSEMBLY PRODUCING THE HIGHER QUALITY FINISHED PRODUCT. CONTACT ARCHITECT FOR FURTHER CLARIFICATION OF INTENT IF CONFLICTS ARE IDENTIFIED.

17. WHEN A WALL OR FLOOR PENETRATION IS REQUIRED, THE CONTRACTOR IS RESPONSIBLE FOR THE MAKING THE PENETRATION NEAT AND ORDERLY. THE RESPONSIBLE CONTRACTOR WILL ALSO PATCH, REPAIR AND PAINT THE AREA TO MATCH ADJACENT FINISHES, UNLESS OTHERWISE NOTED.

PROJECT DATE:

SHEET TITLE:


FLOOR PLAN


10/05/2015

A1.01



NOTES				
12	SUSPENDED PIPE GRID FOR TEMPORARY THEATRICAL LIGHTING, BY OTHERS.			
13	DRYWALL FASCIA TO CEILING, RE: ELEVATIONS.			
17	DRYWALL SOFFIT AND FASCIA. RE: ELEVATIONS AND DETAILS			
20	CONTRACTOR TO INSTALL OWNER-PROVIDED MOTORIZED PROJECTION SCREEN.			
30	CEILING COVE, RE: ELEVATIONS.			
Ξ1	PROVIDE 200 AMP SERVICE (TOTAL) AT INDICATED LOCATION. COORDINATE RECEPTACLE TYPE AND FINAL LOCATION W/ THEATER AND AV CONSULTANTS. RE: ENG. DWGS.			
<b>Ξ</b> 4	TELCO SERVICE ENTRY POINT. PROVIDE FIRE RETARDANT PLYWOOD BACK BOARD OWNER-PROVIDED TELCO EQUIPMENT.			
<b>Ξ</b> 7	PROVIDE J-BOX ABOVE CEILING FOR OWNER-PROVIDED MOTORIZED PROJECTION SCREEN.			
≣8	PROVIDE J-BOX ABOVE CEILING FOR OWNER-PROVIDED MOTORIZED BLACKOUT BLINDS.			
Ξ9	PROVIDE J-BOX ABOVE CEILING FOR MOTORIZED ROLL-DOWN SECURITY GRILL.			
<b>Ξ12</b>	PROVIDE J-BOX ABOVE CEILING FOR OWNER-PROVIDED PROJECTOR.			
Ξ13	INSTALL SEMI-RECESSED WALL-MOUNT LIGHT FIXTURE HORIZONTALLY OVER MIRROR.			

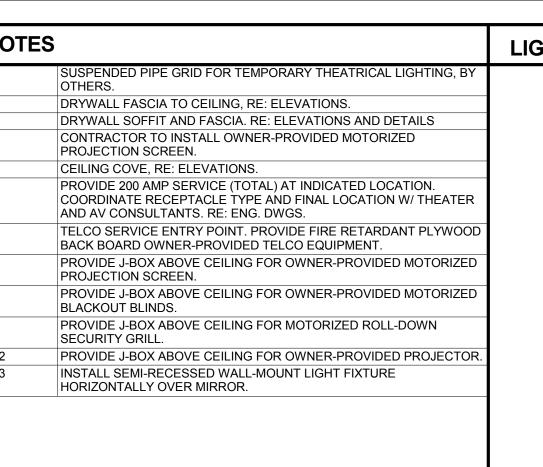

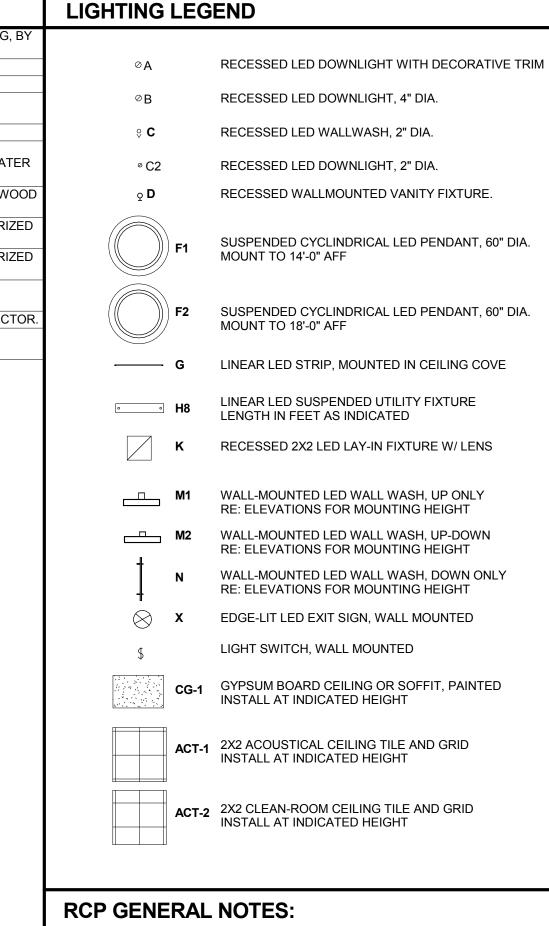

CONTRACTOR SHALL FIELD VERIFY ALL EXISTING CONDITIONS & BECOME FAMILIAR WITH ALL WORK & DIMENSIONS. THE CONTRACTOR SHALL NOTIFY THE ARCHITECT OF ANY OBSTRUCTIONS, CONDITIONS OR DISCREPANCIES ADVERSELY AFFECTING THE DESIGN & LIGHTING INSTALLATION PRIOR TO PROCEEDING WITH THE WORK (INCLUDING CONFLICTS WITH MECHANICAL DUCTS & STRUCTURE.)

LIGHT FIXTURE SUBSTITUTIONS SHALL NOT BE PERMITTED WITHOUT WRITTEN APPROVAL FROM THE OWNER OR THE ARCHITECT.

ALL NEW RECESSED DOWNLIGHTS, WALLWASHERS, SPEAKERS & EXIT SIGNS ARE TO BE LOCATED IN THE CENTER OF THE 2X2 SECTION OF CEILING TILE U.N.O.

4. WHERE MORE THAN ONE SWITCH OCCURS IN THE SAME LOCATION THEY SHALL BE INSTALLED IN A GANG-TYPE BOX UNDER ONE COVERPLATE, U.N.O. DECORA SWITCHES, WHITE.

THERMOSTATS SHALL BE MOUNTED AT BUILDING STANDARD HEIGHT. SEE ENGINEERING DRAWINGS FOR LOCATION. COORDINATE

LOCATION W/ ARCHITECT PRIOR TO INSTALLATION. 6. RELOCATE, EXTEND & MODIFY EXISTING SPRINKLER LINES & HEADS

AS REQUIRED. SPRINKLER HEADS TO BE CONCEALED TYPE.

7. LIGHT SWITCHES & COVERPLATES ARE TO BE MOUNTED VERTICALLY TO CENTER.

MECHANICAL ENGINEER IS TO LAY OUT & CONTRACTOR TO BALANCE HVAC SUPPLY DIFFUSERS & RETURN AIR GRILLES.

9. ARCHITECTURAL DRAWINGS FOR LIGHTING, POWER & TELEPHONE LOCATION ARE FOR SPECIFICATION, LOCATION & QUANTITIES ONLY. SEE ENGINEERING DRAWINGS FOR TECHNICAL INFORMATION. THE CONTRACTOR IS TO NOTIFY THE ARCHITECT OF ANY DISCREPANCIES BETWEEN THE ENGINEERING & ARCHITECTURAL DRAWINGS.

10. CONTRACTOR SHALL PROVIDE ALL LIFE SAFETY ELEMENTS AS REQ'D PER CODE INCLUDING BUT NO LIMITED TO HORNS, SMOKE DETECTORS, SPRINKLERS, LAYOUT OF DETECTORS & SPRINKLERS, EXIT SIGNS, AREA OF EVACUATION ASSISTANCE, ETC.

11. CONTRACTOR SHALL COORDINATE THE INSTALLATION OF THE VARIOUS TRADE ITEMS WITHIN THE SPACE ABOVE ALL CEILINGS (INCLUDING, BUT NOT LIMITED TO: STRUCT. MEMBERS, MECH. DUCTS AND INSUL., LIGHT FIXTURES, CEILING SYSTEMS, AND ANY SPECIAL STRUCT. SUPPORTS REQUIRED) AND SHALL BE RESPONSIBLE FOR MAINTAINING THE FINISH CEILING HEIGHT ABOVE THE FINISH FLOOR INDICATED IN THE DRAWINGS AND THE FINISH SCHEDULE.

12. CONTRACTOR IS RESPONSIBLE FOR COORDINATING THE LOCATION OF ALL CEILING FRAMING MEMBERS TO FACILITATE THE INSTALLATION OF ALL CEILING MOUNTED ELEC. AND MECH. DEVICES, ETC., PER THE ARCHITECT'S DRAWINGS. IF NOT DIMENSIONED, COORDINATE LOCATIONS WITH ARCHITECT PRIOR TO INSTALLATION.

13. ACCESS PANELS SHALL BE PROVIDED AND INSTALLED WHEREVER REQUIRED BY BLDG. CODE OR FOR THE PROPER OPERATION OR MAINTENANCE OF MECH. OR ELEC. EQUIPMENT, WHETHER OR NOT INDICATED ON THE DRAWINGS. CONTRACTOR SHALL COORDINATE SIZE, LOCATION, AND TYPE OF ACCESS PANEL WITH OTHER CONTRACTORS' WORK AND RECEIVE APPROVAL OF THE ARCHITECT. NO ACCESS PANEL SHALL BE LOCATED, FRAMED OR INSTALLED WITHO THE EXPRESS APPROVAL OF THE ARCHITECT. PAINT PANELS TO MATCH ADJACENT FINISHED CONDITION OR AS APPROVED BY ARCHITECT.

14. ALL DUCT PENETRATIONS THROUGH PARTITIONS AND CEILINGS SHALL BE PROVIDED WITH THE NECESSARY FRAMES AND BRACING AROUND THE OPENING.

15. THE CONTRACTOR SHALL PROVIDE ROOF PATCH AND FLASHING CONDITIONS AT ALL ROOF PENETRATIONS/CURBS, TO BE COMPATIBLE WITH EXISTING ROOF MEMBRANE. PROVIDE TEMPORARY WEATHER PROTECTION AS REQUIRED. EXECUTE WORK SO AS TO MAINTAIN ANY EXISTING ROOF WARRANTIES.

16. CEILING SYSTEMS SHALL PROVIDE FOR LIGHTING FIXTURES AND AIR CONDITIONING DIFFUSERS. INDEPENDENT FRAMING AND ATTACHMENTS TO THE STRUCT. SHALL BE ADEQUATE TO SUPPORT THE CEILING SYSTEM WHERE DUCTWORK INTERFERES WITH NORMAL SUSPENSION. ATTACHMENT OF HANGERS OR FRAMING TO DUCTWORK IS PROHIBITED.

17. WHEN A CEILING PENETRATION IS REQUIRED, THE CONTRACTOR IS RESPONSIBLE FOR THE MAKING THE PENETRATION NEAT AND ORDERLY. THE RESPONSIBLE CONTRACTOR WILL ALSO PATCH, REPAIR AND PAINT THE AREA TO MATCH ADJACENT FINISHES, UNLESS OTHERWISE NOTED.



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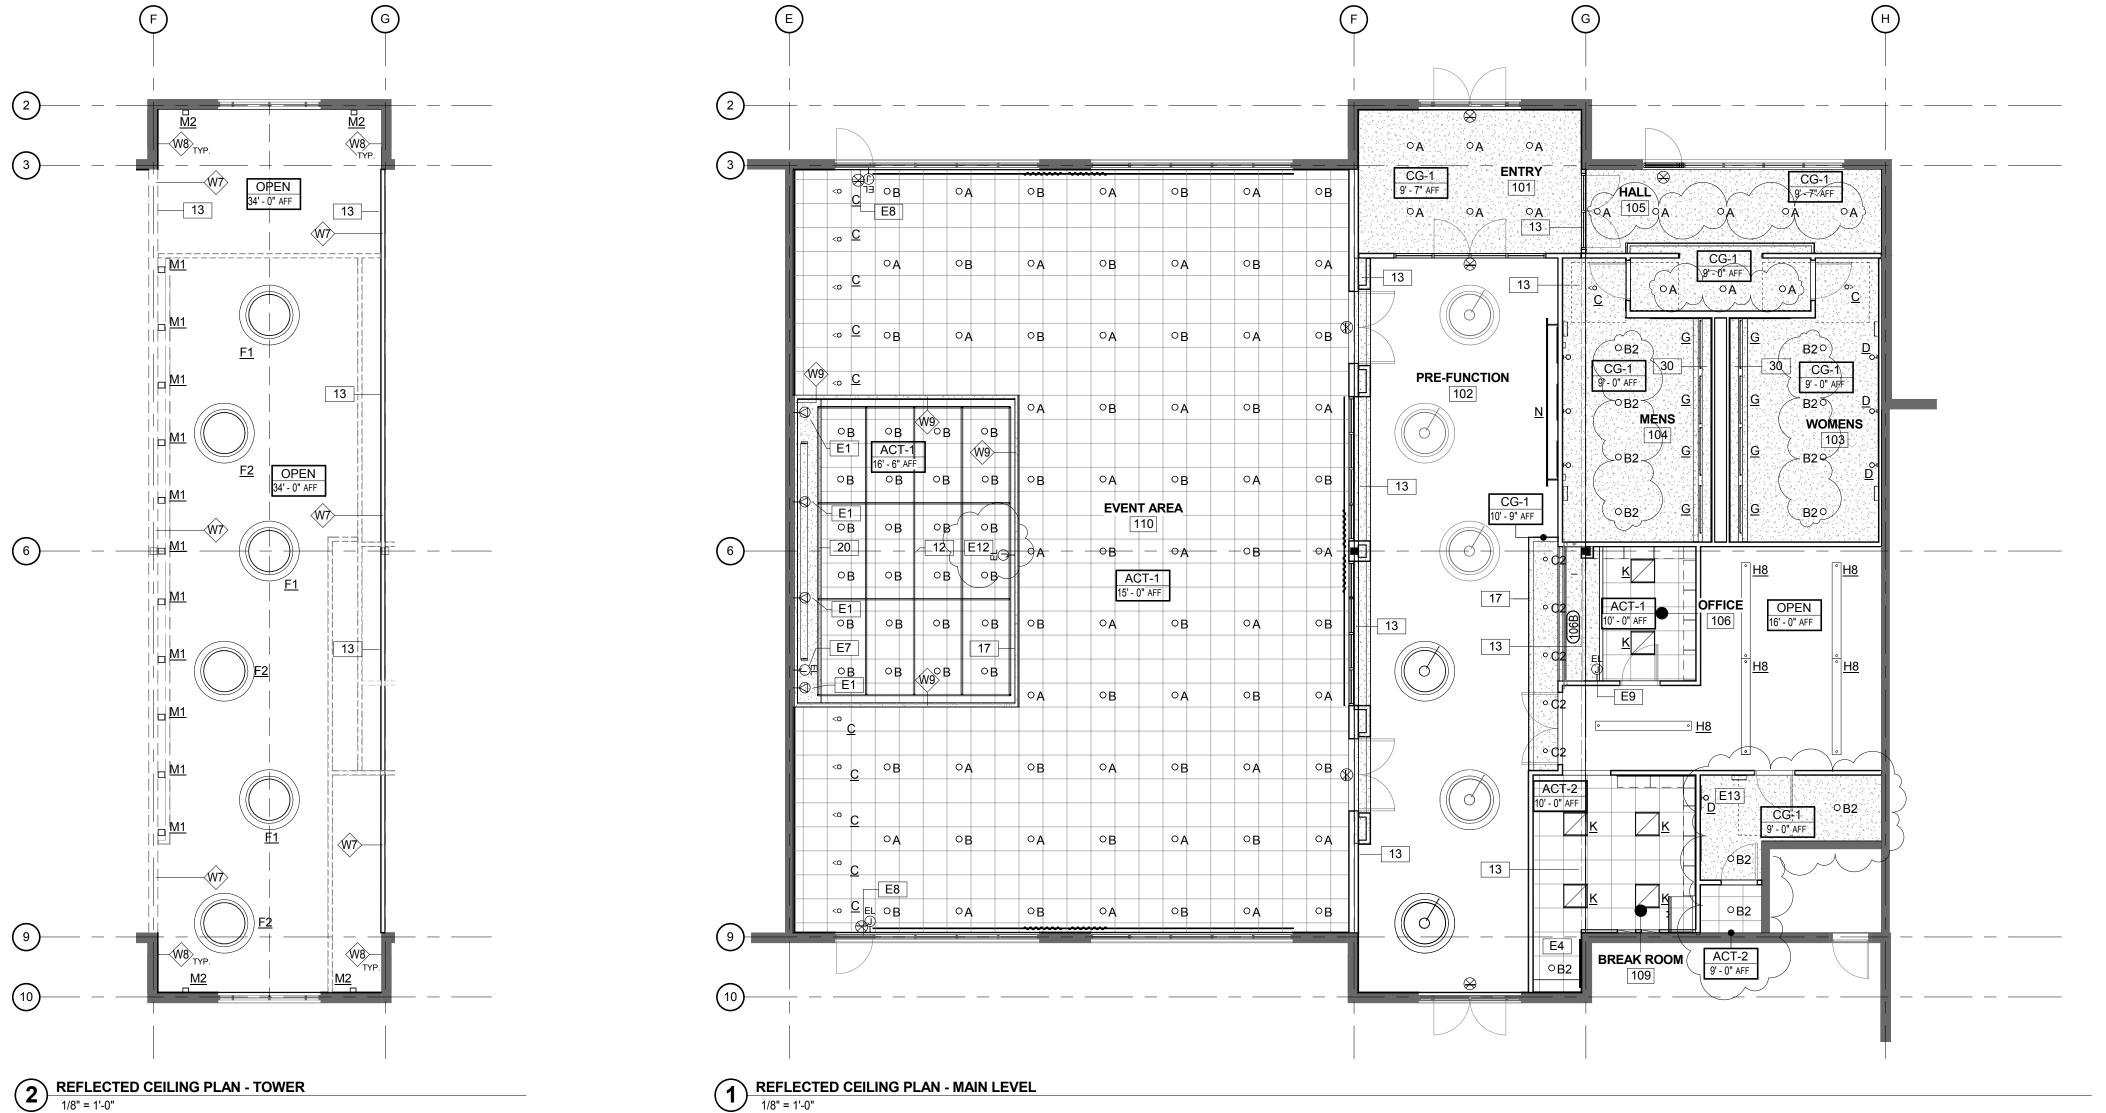
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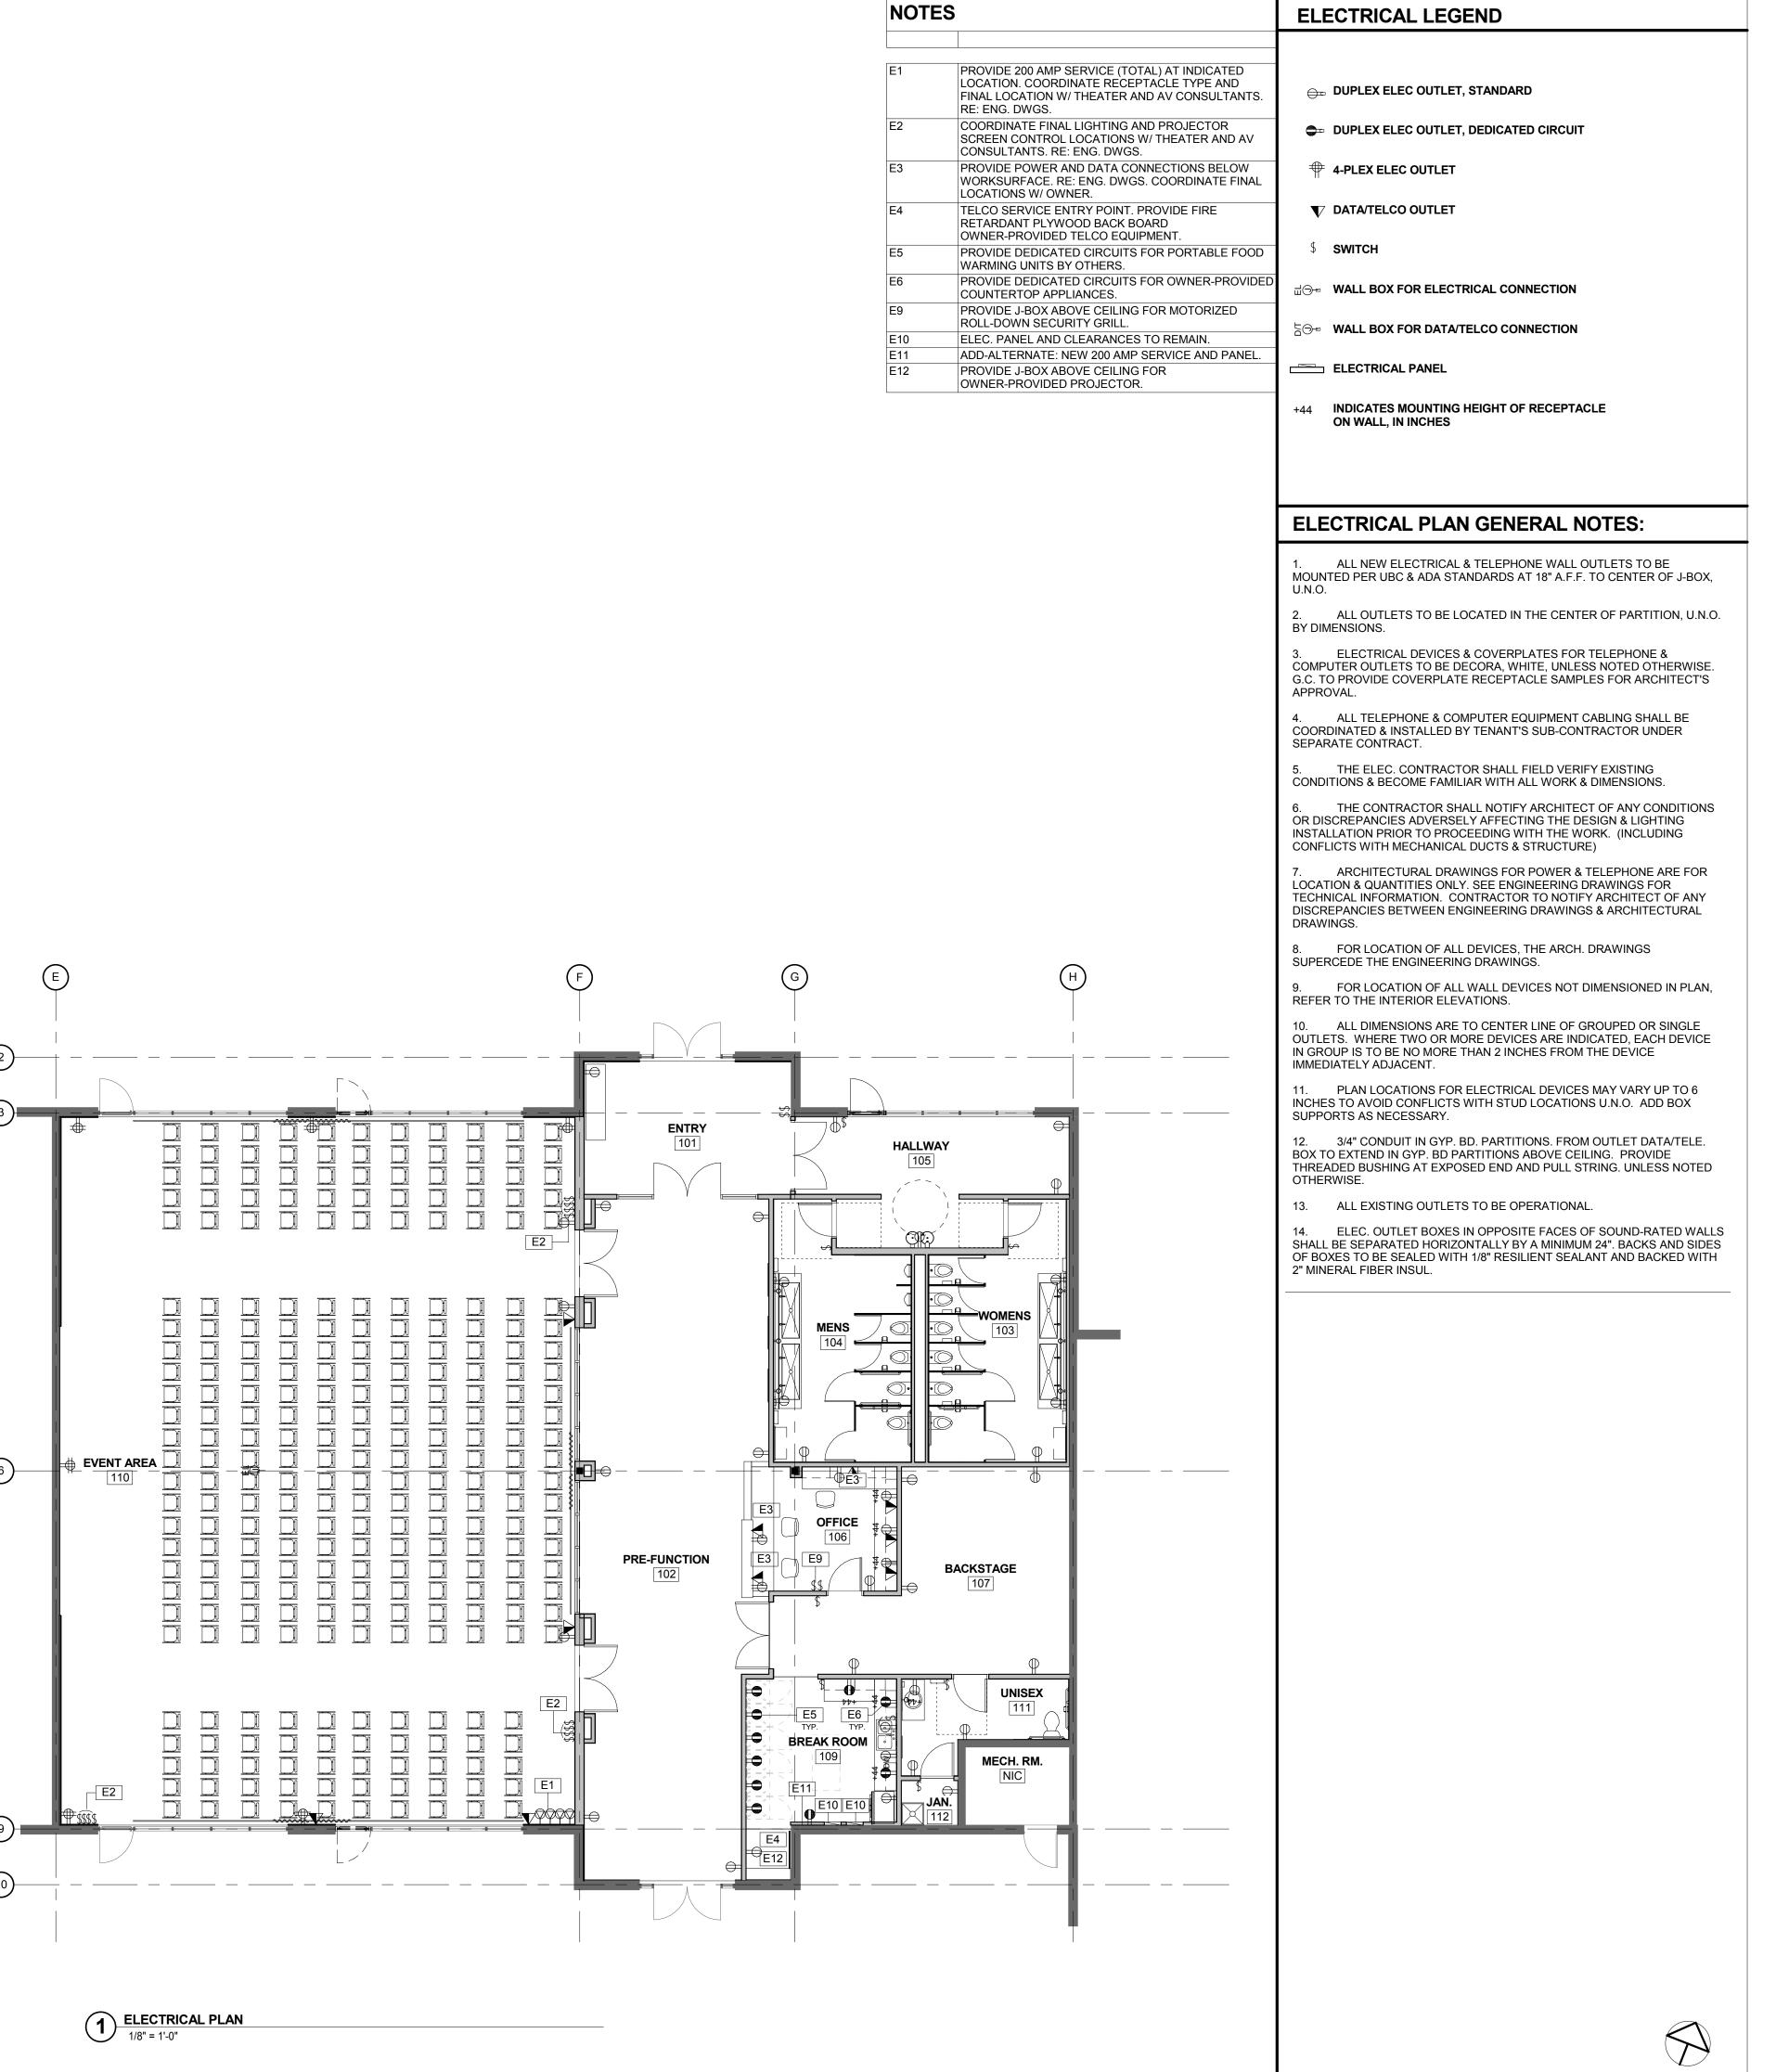
PROJECT DATE: SHEET TITLE:

REFLECTED CEILING PLAN

A1.02

10/05/2015





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The Shops at Conservatory (8371 Northfield Boulevard Denver, CO

REVISION OWNER REVIEW | 12/18/2015


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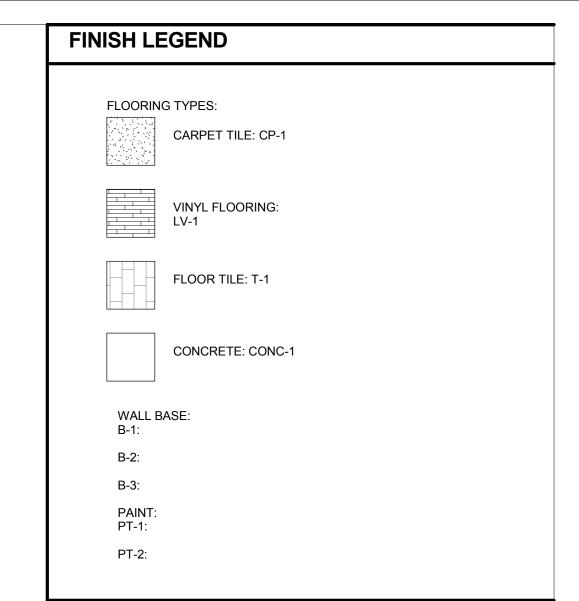
PROJECT NUMBER:

PROJECT DATE: SHEET TITLE:

ELECTRICAL PLAN

A1.03



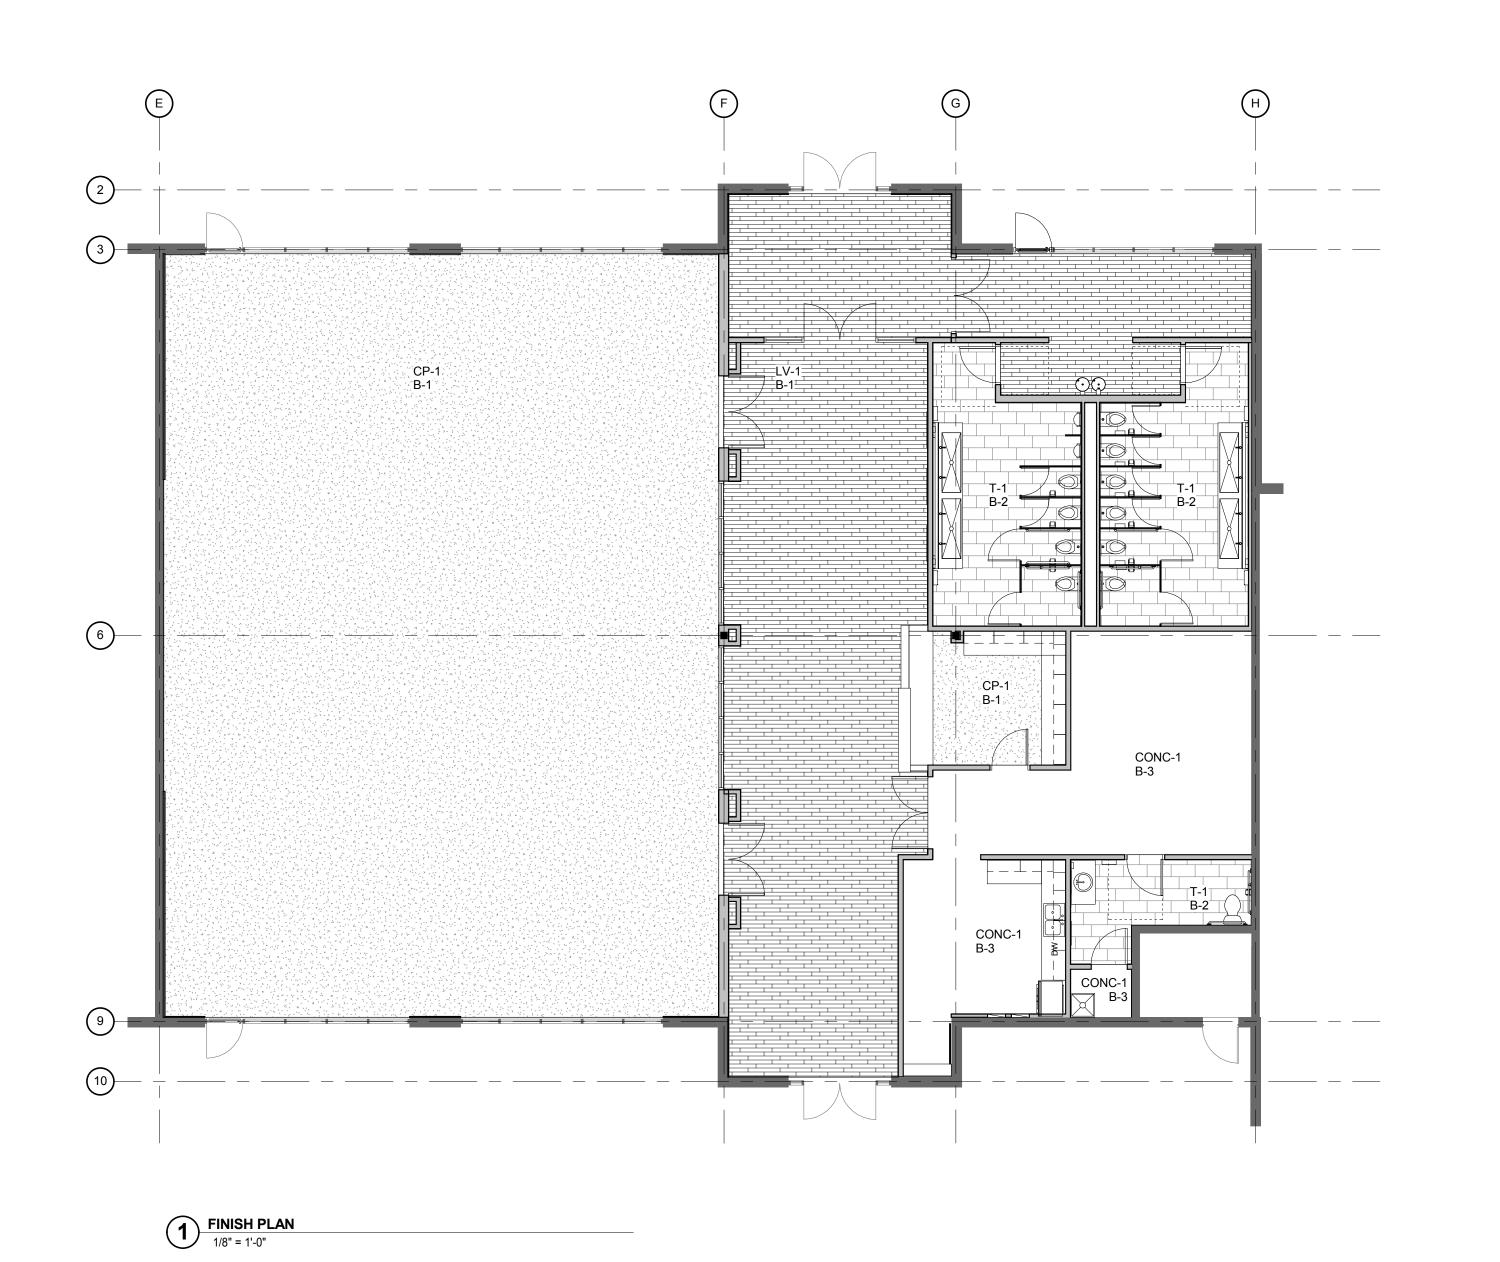

### FINISH PLAN GENERAL NOTES:

PAINT ALL WALLS WF - 1, UNLESS OTHERWISE NOTED.

2. PAINT EXISTING GYPSUM BOARD CEILINGS TO LIKE NEW CONDITIONS, MATCH EXISTING COLOR.

3. CONTRACTOR SHALL BE RESPONSIBLE FOR FIELD INSPECTION OF THE SURFACES TO RECEIVE PAINT OR OTHER FINISH TREATMENT AND FOR DETERMINING THAT SUCH SURFACES ARE ACCEPTABLE FOR FINISH APPLICATION PRIOR TO INITIATING ACTUAL FINISH WORK. NO PAINT FINISH SHALL BE APPLIED ON ANY SURFACE WHICH IS UNFINISHED, IMPROPERLY PREPARED OR OTHERWISE NOT FULLY ACCEPTABLE FOR THE FINISH APPLICATION. ALL ROUGHNESS OR OTHER IRREGULARITIES THAT MAY APPEAR AFTER PRIMING SHALL BE THOROUGHLY FILED OR SANDED OUT OR OTHERWISE CORRECTED TO PROVIDE A SMOOTH, EVEN SURFACE FOR PAINTING AND FINISHING. FINISHED APPLICATION AND WALL APPEARANCE SHALL BE FREE OF SURFACE AND COLOR IRREGULARITIES.

4. ALL DRYWALL FINISHES SHALL BE SMOOTH, UNLESS OTHERWISE

5. DRYWALL PAINT, UNLESS OTHERWISE NOTED, SHALL BE ACRYLIC LATEX, FINISH NOT SUSCEPTIBLE TO BURNISHING UNDER NORMAL OFFICE AND COMMERCIAL WEAR.

6. ALL PAINT FINISH ON METAL PARTS OF FRAMES, DOORS, PERIMETER ENCLOSURES, ETC. AND ALL PAINTED MILLWORK SHALL BE SEMI-GLOSS ENAMEL, UNLESS OTHERWISE NOTED. ALL DOORS SHALL BE THE SAME FINISH ON BOTH SIDES, UNLESS OTHERWISE NOTED.

7. FLASH-PATCH AREAS WHERE FLOOR IS NOT LEVEL OR TRUE PRIOR TO FLOORING INSTALLATION.

8. REFER TO INT. ELEV. FOR ADD'L FINISH INFO.

9. ALL PAINTED DOORS AND FRAMES TO MATCH ADJACENT WALL COLOR U.N.O.

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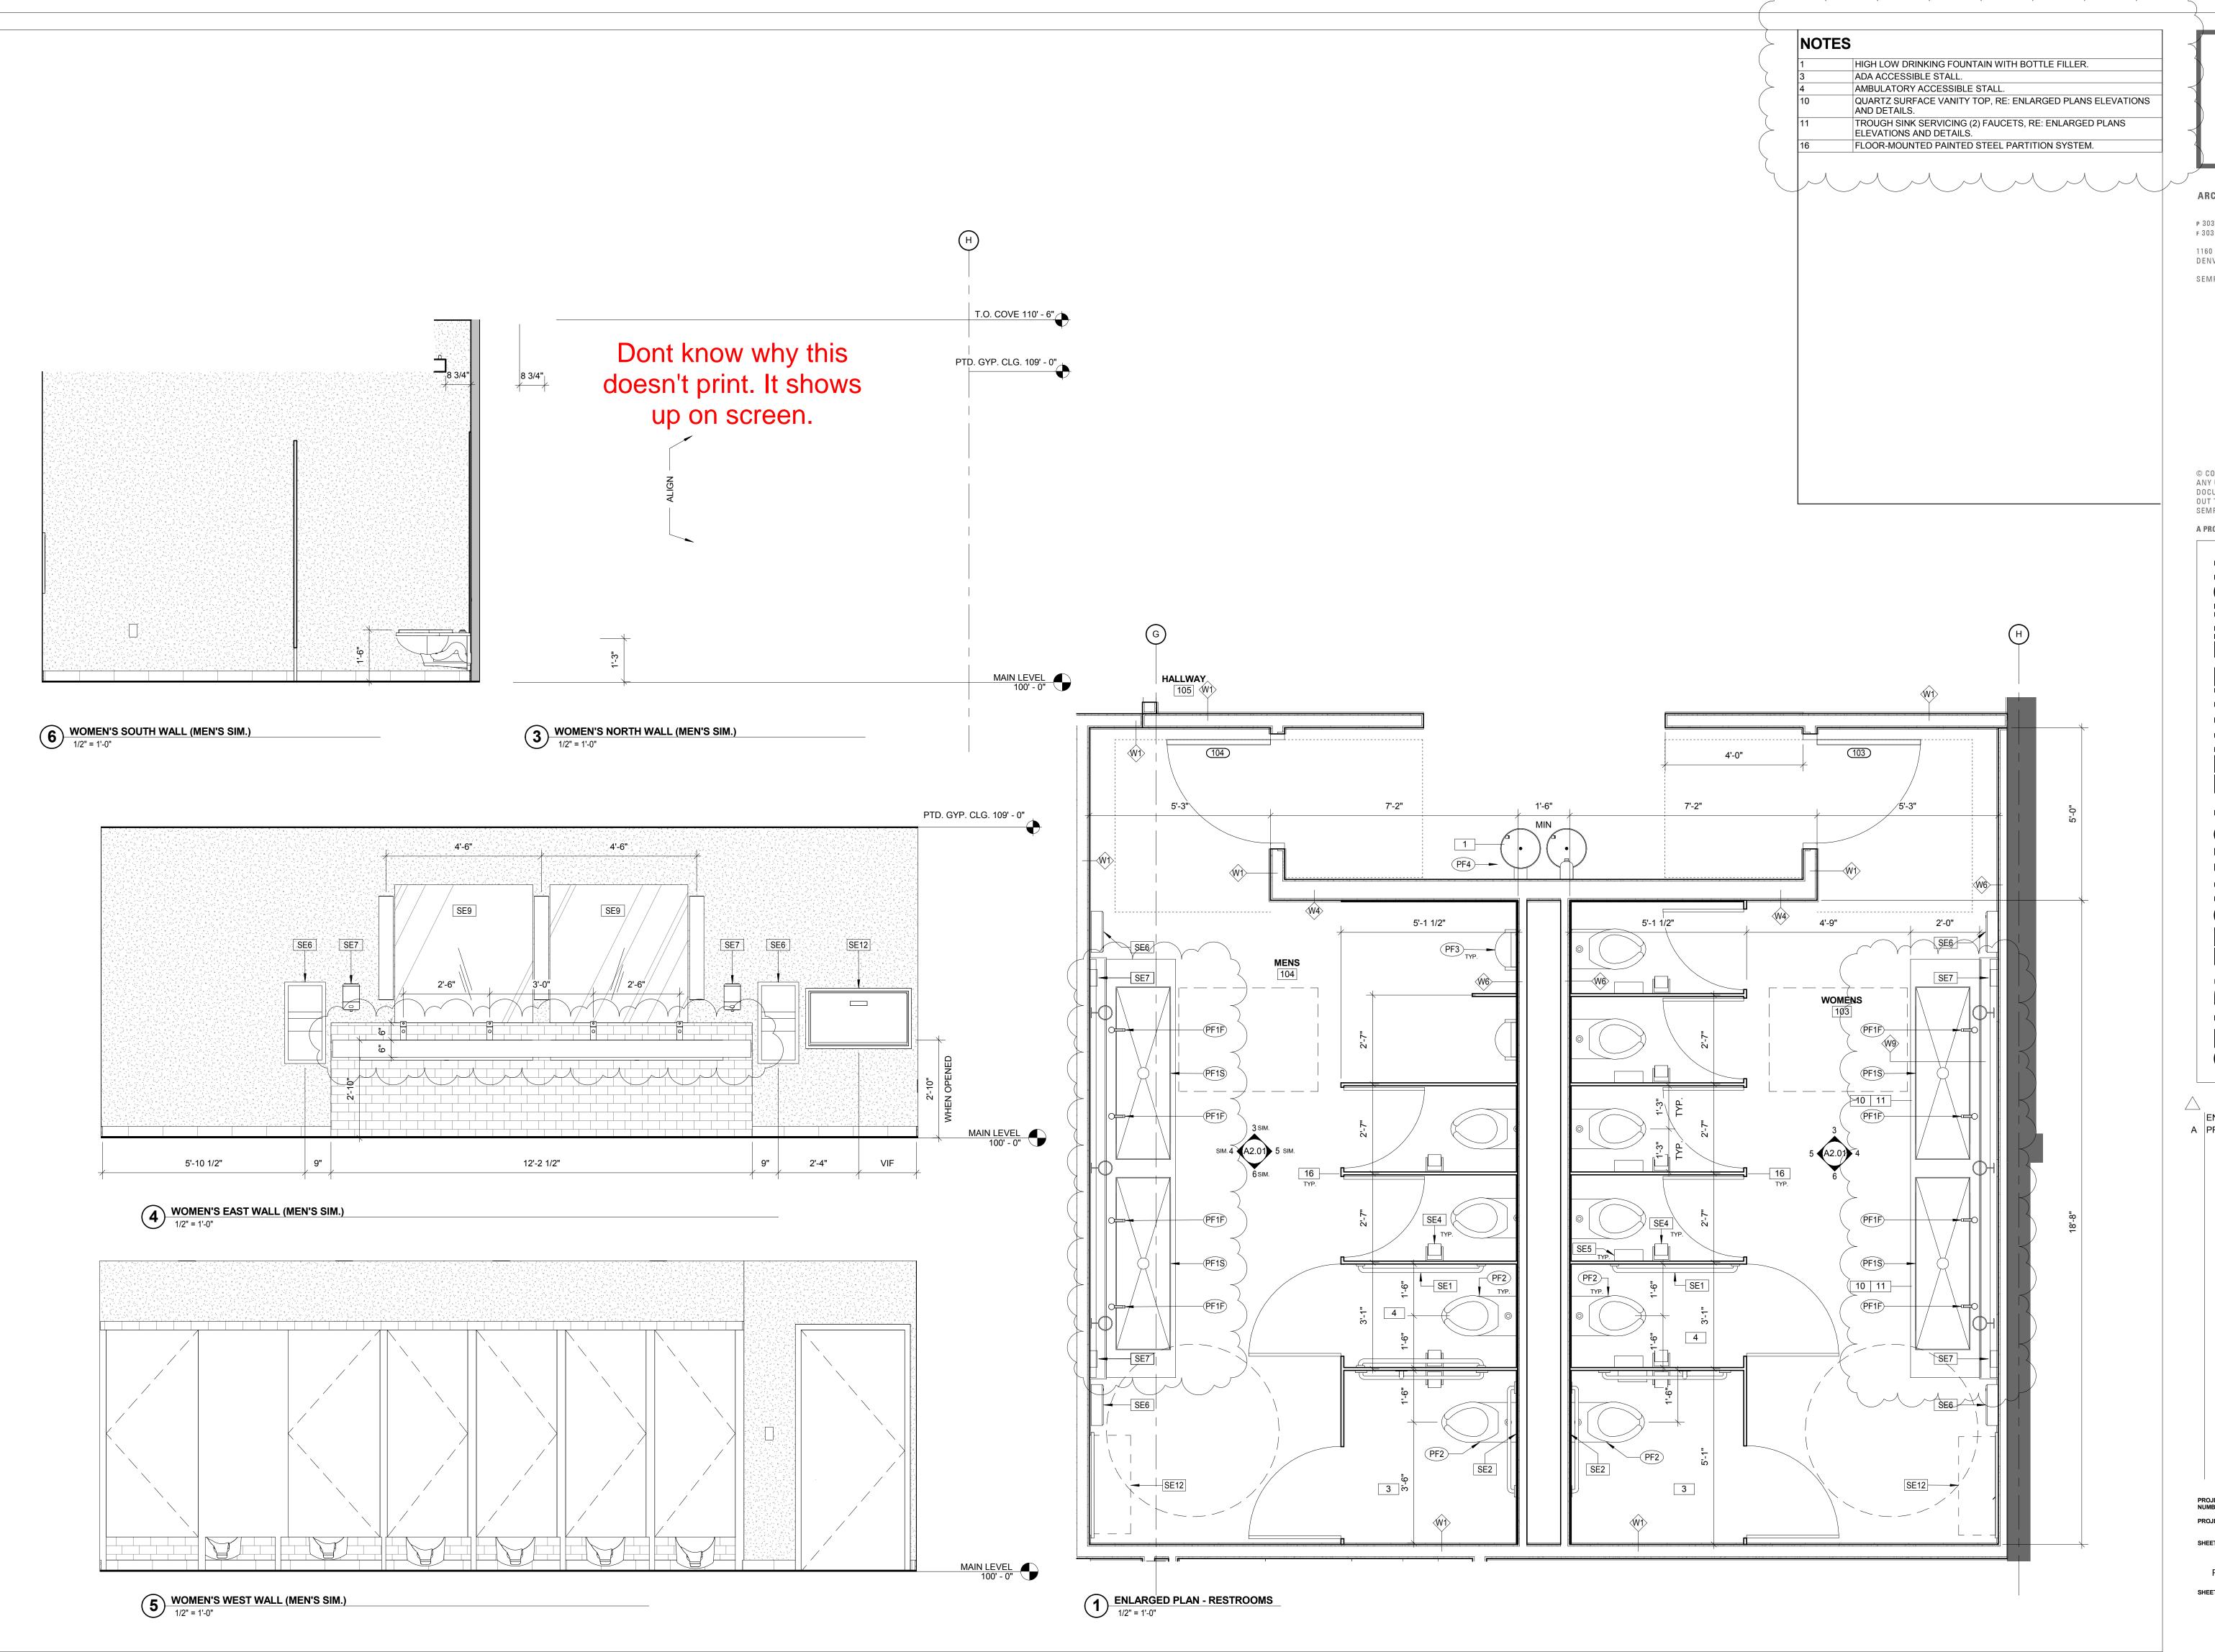
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**FINISH TENANT** 

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A1.04



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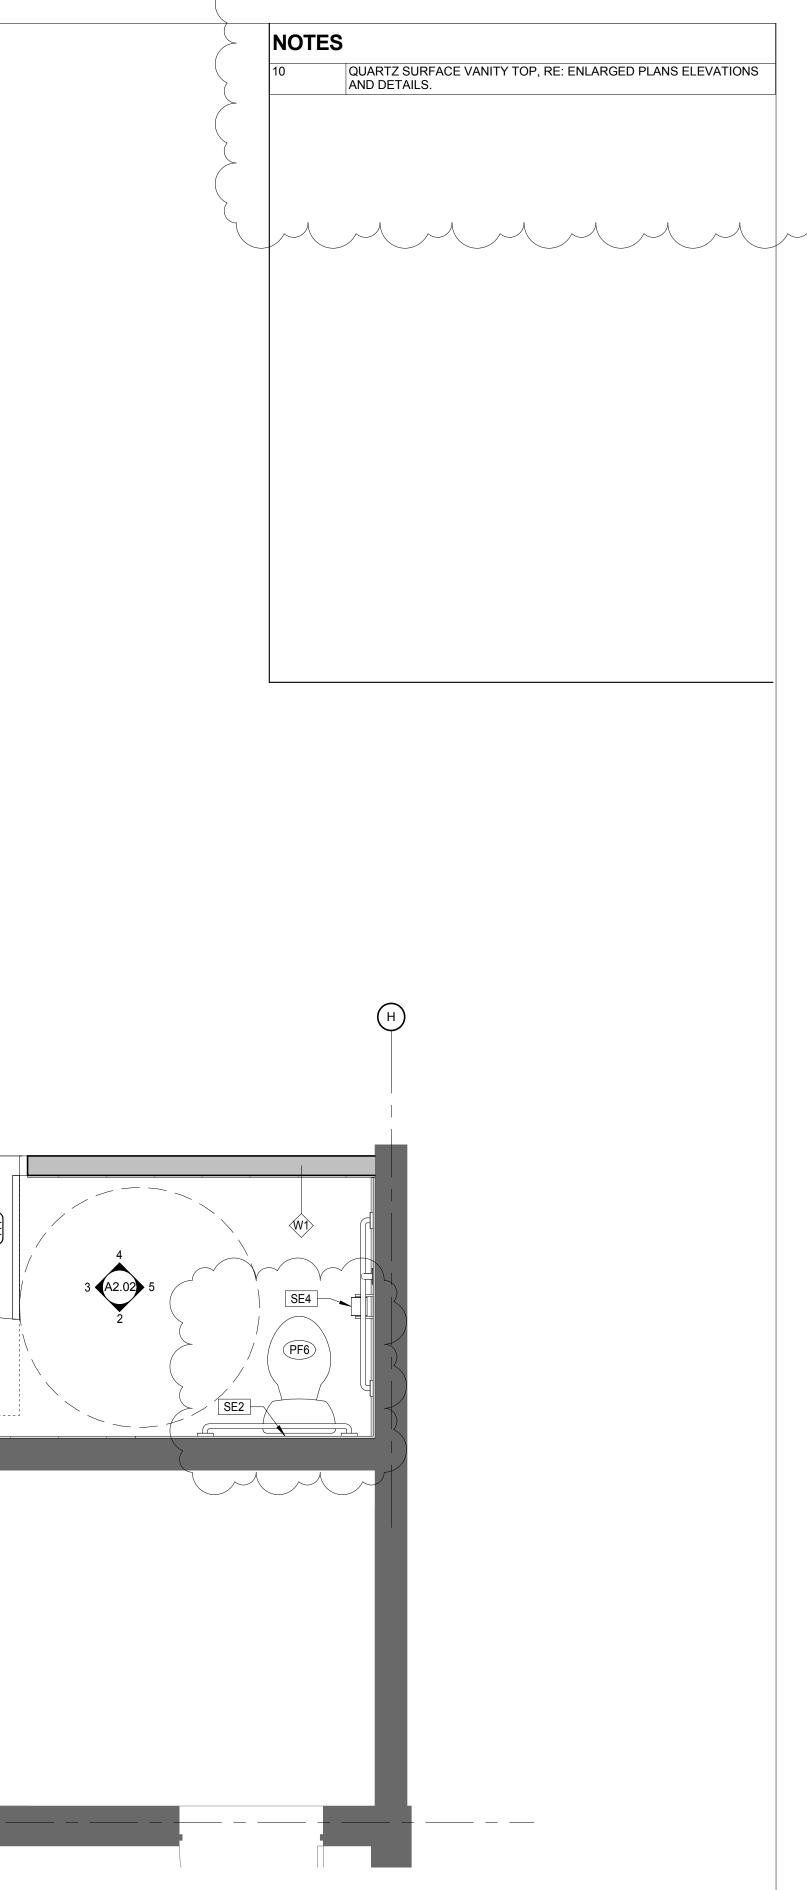
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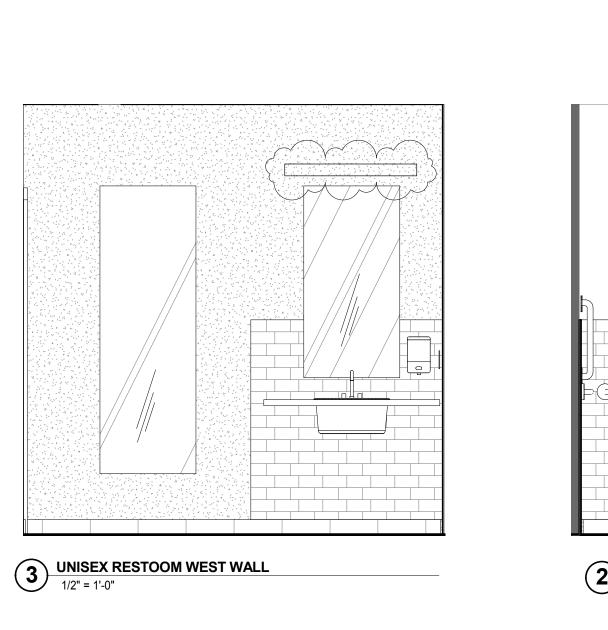
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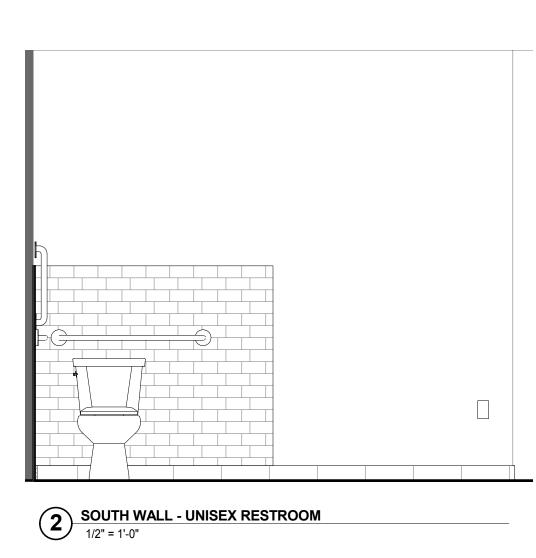
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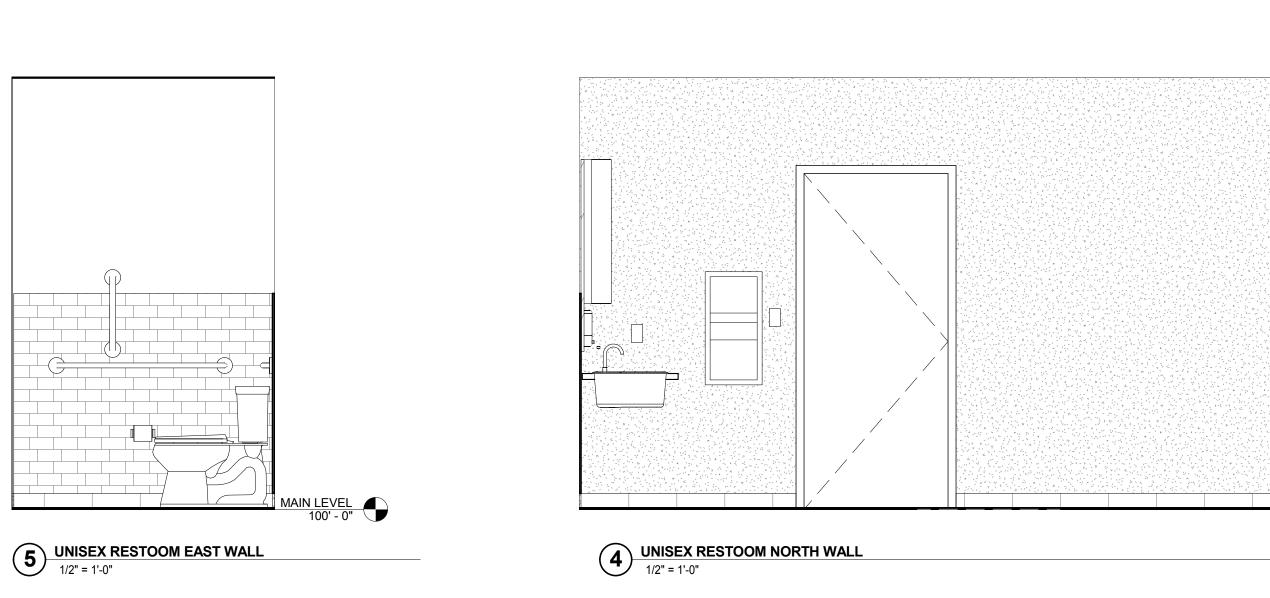
ENLARGED RESTROOM PLANS AND ELEVATIONS


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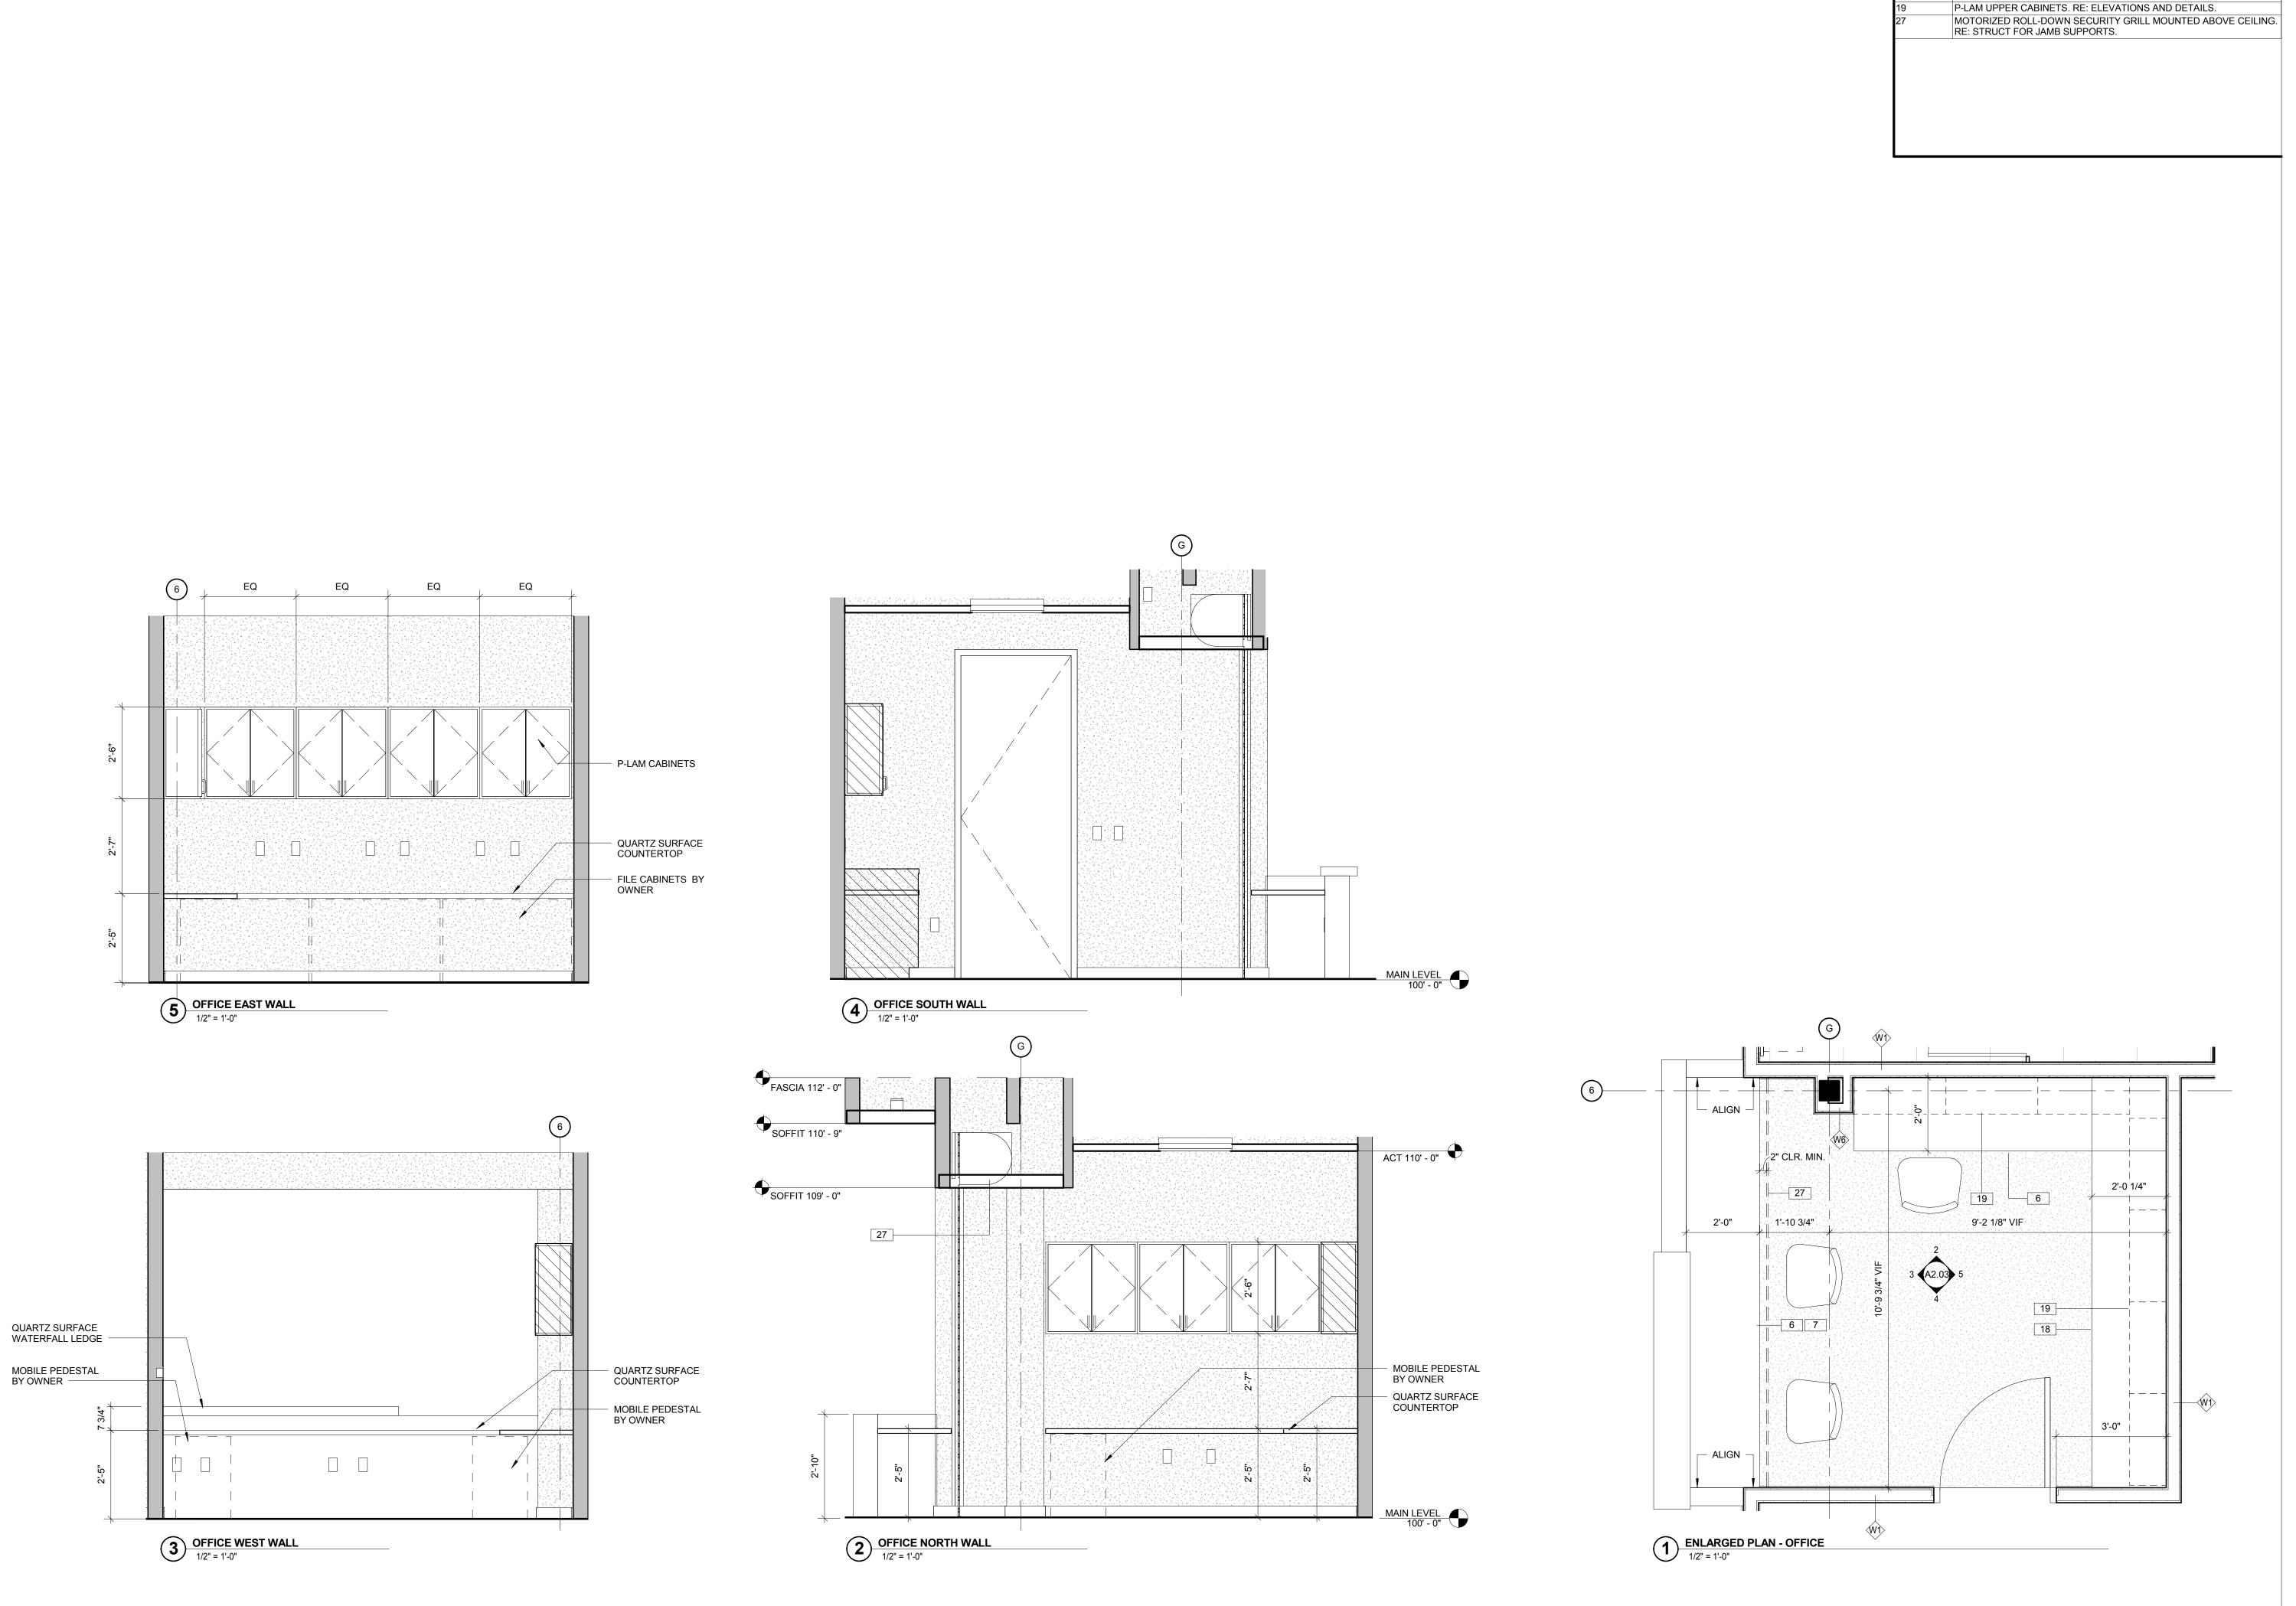
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PROJECT NUMBER: PROJECT DATE:

SHEET TITLE: ENLARGED BACK-OF-HOUSE PLANS AND ELEVATIONS

A2.02



NOTES

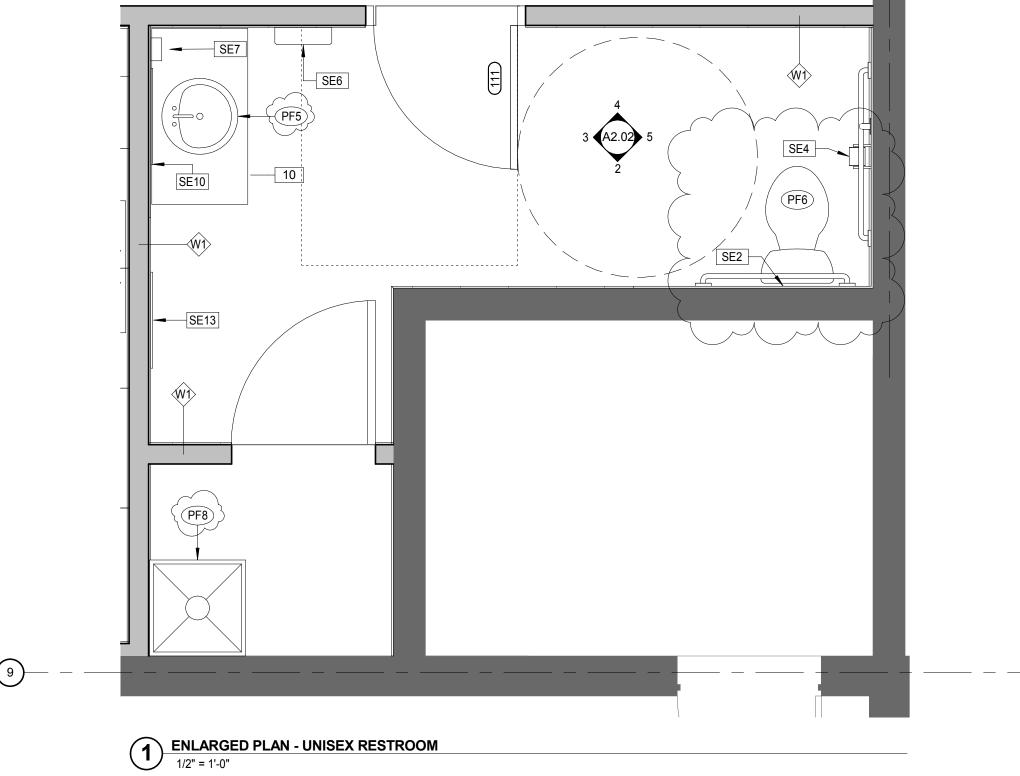WORK SURFACE W/ 2" DIA. GROMMETS FOR POWER/DATA

WOOD VENEER RECEPTION DESK WITH QUARTZ SURFACE

TRANSATION TOP, RE: ENLARGED PLANS ELEVATIONS AND DETAILS.

P-LAM BASE CABINETS AND COUNTERTOP. RE: ELEVATIONS AND

CONNECTION. RE: ELEVATIONS AND DETAILS

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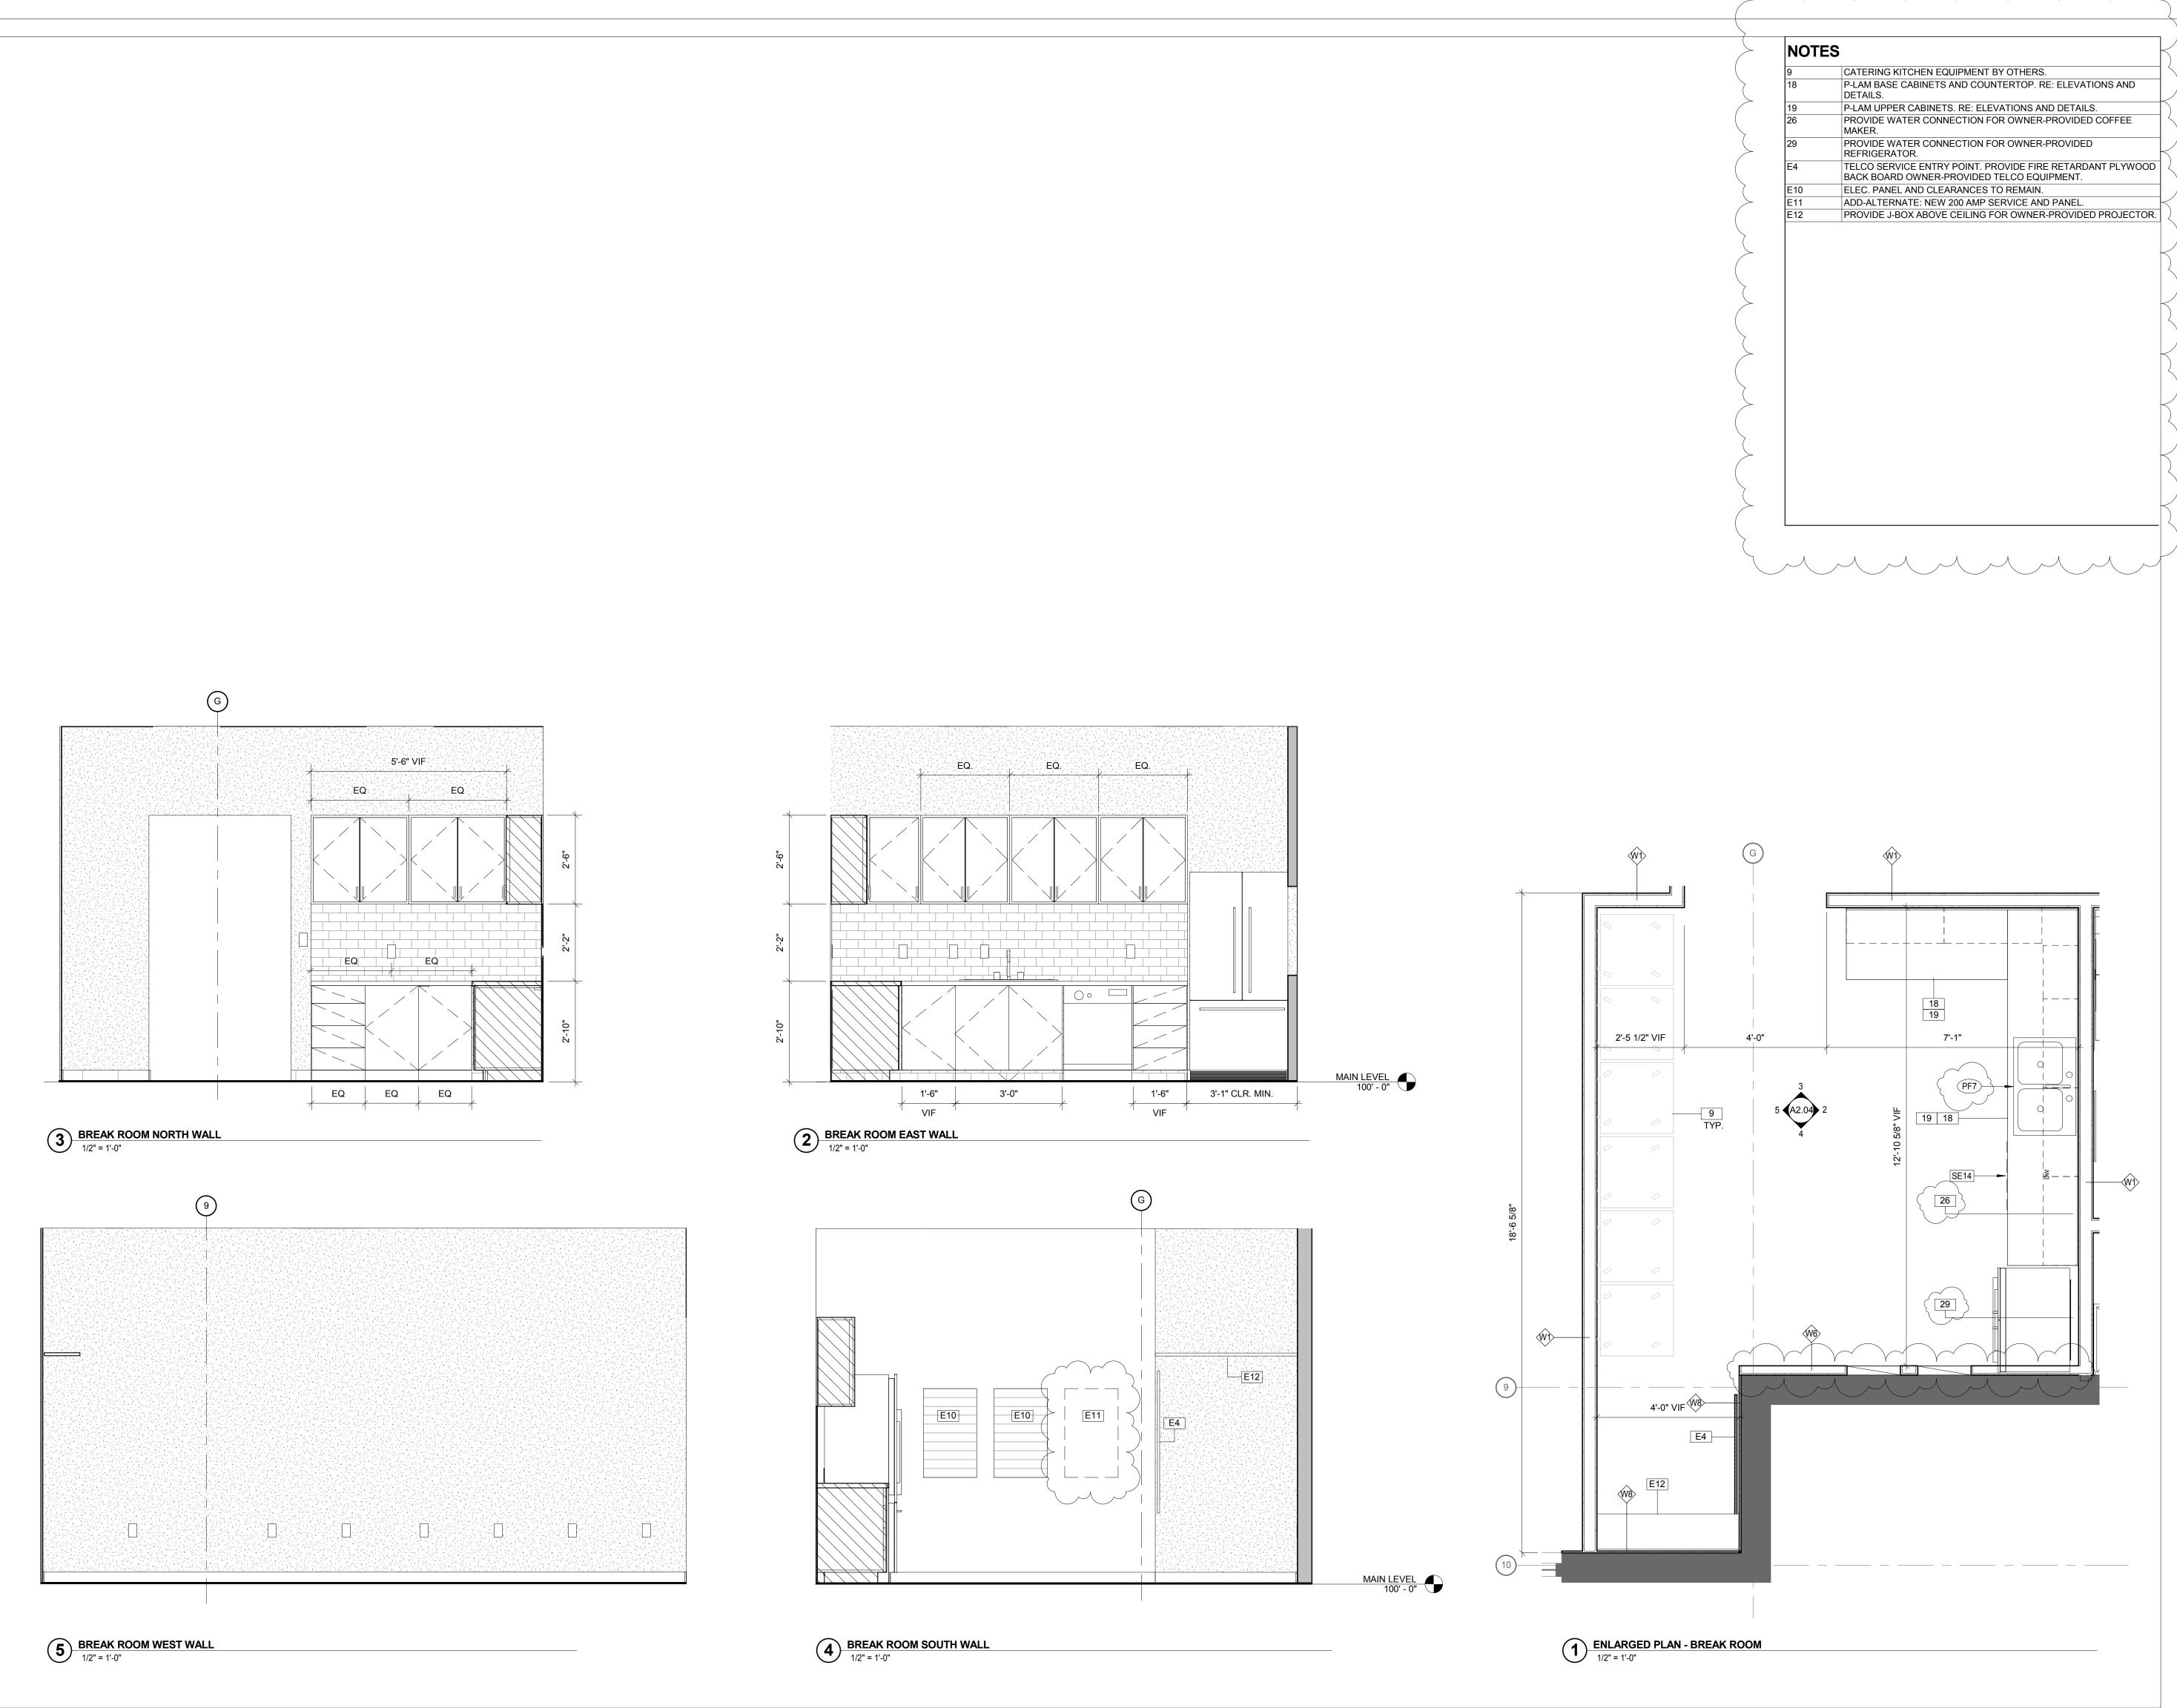
**FINISH** 

TENANT MCA STAPLETON

REVISION ENGINEERING **DATE** 01/29/2016

PROJECT NUMBER: PROJECT DATE: SHEET TITLE:

> ENLARGED OFFICE PLANS AND ELEVATIONS **A2.03**



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FINISH TENANT STAPLETON MCA

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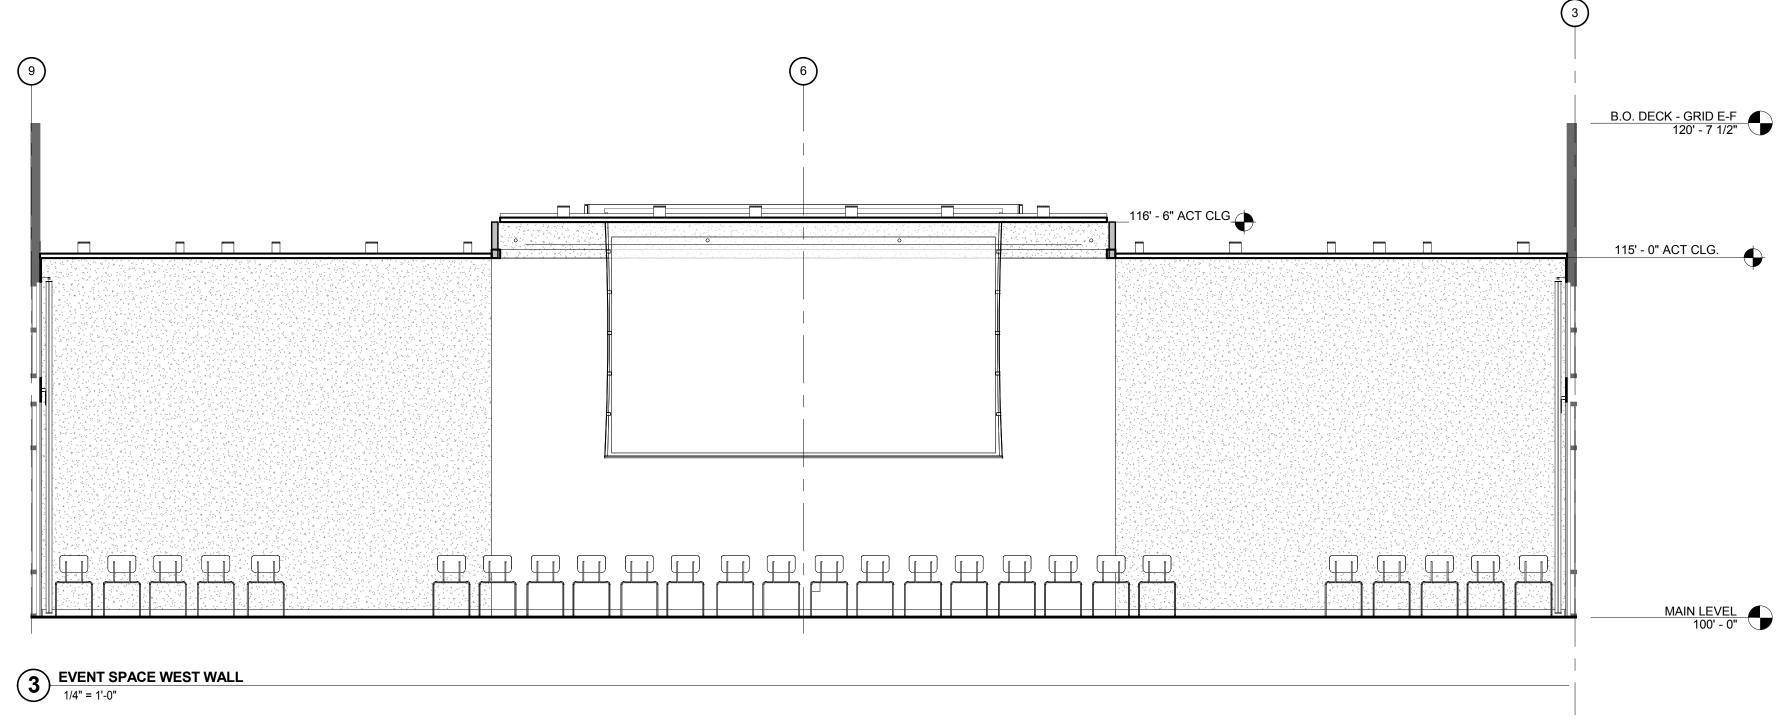
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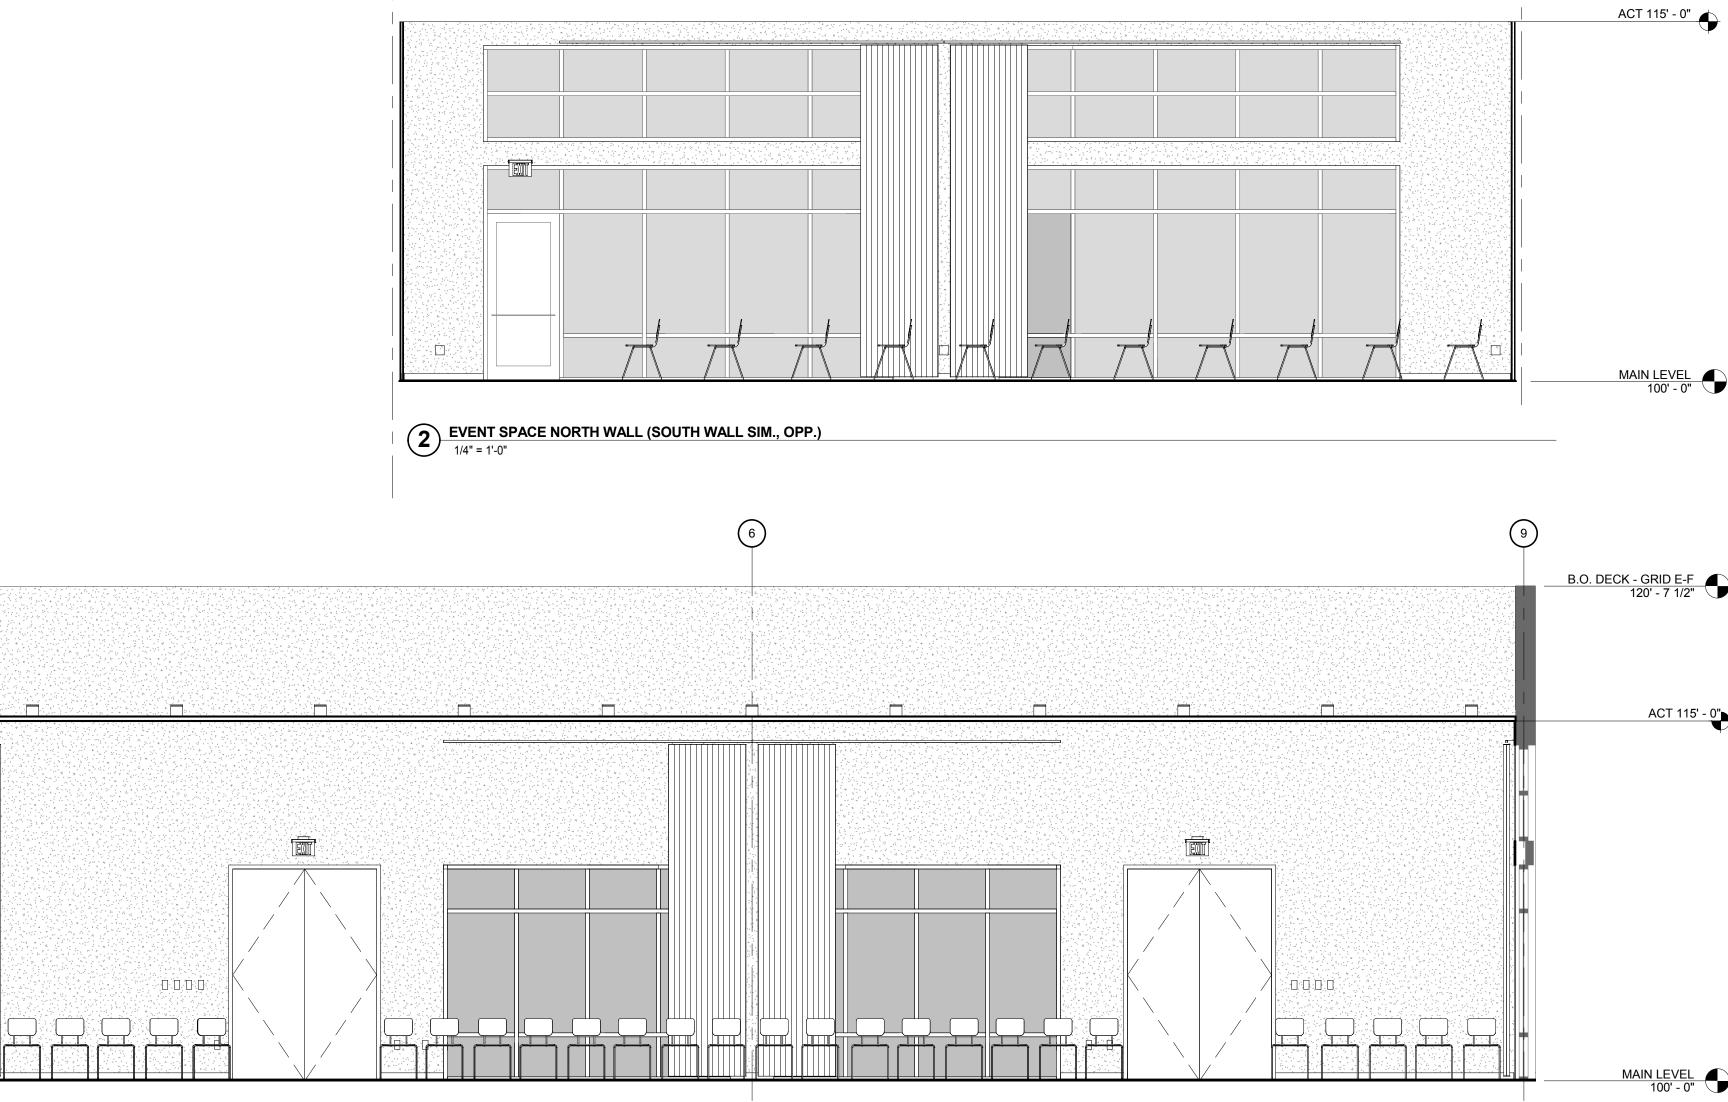
PROJECT DATE:

ENLARGED BREAK ROOM PLANS AND ELEVATIONS

A2.04

01/29/2016





EVENT SPACE EAST WALL

1/4" = 1'-0"

